



AGENDA
Planning and Evaluation Committee
February 9, 2023
1:30-3:00PM
Room 2, West Center / Zoom

Committee: Bart Hillyer (Chair), Robert Quast, Tom Sadowski, Keith Skytta, Stewart Tagg, Diane West, Kathy Zollinger, Kathi Bachelor (ex officio), Scott Somers (CEO), David Jund (Facilities Director/Liaison)

Agenda Topic

- 1. Call to order, Roll Call, and Establish Quorum**
- 2. Adopt Agenda**
- 3. Approve January 12, 2022 Meeting Minutes**
- 4. Chair comments** (Hillyer)
- 5. Staff Reports** (Jund)
 - Project updates
 - a. Desert Hills Fitness Expansion
 - b. Del Sol Clubhouse
 - c. Glass Artists Tenant Improvement
 - d. Ceramics Expansion at Desert Hills
 - e. Industrial Arts Complex
- 6. New Business**
- 7. Adjournment**
- 8. Next Meeting** – Thursday, March 9, 2023 1:30PM



MINUTES

Planning & Evaluation Committee
Thursday, January 12, 2023
1:30pm – 3:00pm MST
West Center Room 2 / Zoom

Committee: Bart Hillyer (Chair), Robert Quast, Tom Sadowski, Stewart Tagg, Keith Skytta, Diane West, Kathy Zollinger, Kathi Bachelor (ex officio), Scott Somers (CEO), David Jund (Facilities Director/Liaison)

Agenda Topic

1. **Call to Order / Roll Call - Establish Quorum**
Chair Hillyer called the meeting to order at 1:30pm MST. Roll called; quorum established.

2. Approve August 11, 2022, Meeting Minutes
No objections to adoption. Adopted.

3. **Chair Comments**
No comments

4. **Business**
a. Jund gave an overview of the Projects in Progress.

Motion: Skytta moved, seconded to recommend to the Board of Directors to combine the projects of the expansion of the Ceramics Club space with the Fitness Center Expansion at Desert Hills for potential cost savings purposes. Passes: unanimous

Skytta left meeting at 2:13pm for prior commitment.

5. **Member Comments:** 1 comment

6. **Adjournment**
No objections to adjourn. Meeting adjourned at 2:59 MST

Next Meeting: Thursday, February 9, 2023, 1:30-3:00pm, WC-Rm 2/Zoom

Glass Arts TI at Santa Rita Springs Green Valley Recreation

921 W Via Rio Fuerte, Green Valley, AZ 85614

LEGAL DESCRIPTION

ROADHAVEN RESORTS INC OF GREEN VALLEY
PTN COMMON AREA B RECREATION AREA
PC ASSESSOR TAX PARCEL ID NO:
304-19-2720
BASIS OF ELEVATIONS:
THE BASIS OF ELEVATIONS IS AN ALUMINUM CAP IN A
CONCRETE HEADWALL AT STATION 1969+29.2 ALONG THE
EAST FRONTAGE ROAD OF INTERSTATE 19. SAID ELEVATION-
2921.99
BASIS OF BEARINGS:
THE BASIS OF BEARINGS IS THE EAST RIGHT-OF-WAY LINE OF
INTERSTATE 19. SAID BEARING BEING NORTH 22°23'1" EAST
TOWNSHIP 18S, RANGE 13E, SECTION 34

PROJECT TEAM

OWNER
GREEN VALLEY RECREATION, INC.
1070 S CALLE DE LAS CASITAS
GREEN VALLEY, AZ 85614
520.825.3440

ARCHITECT
WSM, A DIVISION OF SHIVE-HATTERY
4330 N CAMPBELL AVE #268
TUCSON, AZ 85718
520.408.1004

STRUCTURAL ENGINEER
SCHNEIDER AND ASSOCIATES
435 E 9TH ST
TUCSON, AZ 85705
520.512.8183

MECHANICAL ENGINEER
PH MECHANICAL ENGINEERING
333 N WILMONT RD #201
TUCSON, AZ 85711
520.731.2060

ELECTRICAL ENGINEER
ELECTRICAL DESIGN ASSOCIATES (EDA)
7536 N LA CHOLLA BLVD
TUCSON, AZ 85741
520.622.2196

SITE PLAN GENERAL NOTES:

- TOPOGRAPHIC INFORMATION WAS TAKEN FROM A LIMITED FIELD SURVEY BY CENTERLINE OFFSET, INC. PROJECT NO. 991100.
- THE WATER COMPANY THAT SERVICES THIS PROJECT IS FARMER'S WATER COMPANY 1525 SAHUARITA RD, SAHUARITA, AZ 85629 (520) 879-7474
- NO CHANGES TO EXISTING SITE VISIBILITY TRIANGLES.

PC OUTDOOR LIGHTING CODE NOTES:

PC OLC LIGHTING CODE AREA E1A
NO NEW OUTDOOR LIGHT PROVIDED


SHEET INDEX

GENERAL	MECHANICAL
A0.0 COVER SHEET	M0.0 MECHANICAL DEMO FLOOR PLAN
A0.1 GENERAL NOTES, SYMBOLS & ABBREVIATIONS	M1.0 MECHANICAL CEILING PLAN
A0.2 CODE PLAN	M2.0 MECHANICAL NOTES, SCHEDULES & DETAILS
ARCHITECTURAL	PLUMBING
D2.0 DEMOLITION FLOOR PLAN	P0.0 PLUMBING DEMO FLOOR PLAN
A2.0 FLOOR PLAN	P1.0 PLUMBING WASTE FLOOR PLAN
A2.2 EQUIPMENT FLOOR PLAN	P2.0 PLUMBING WATER FLOOR PLAN
A2.0D DIMENSION PLAN	P3.0 PLUMBING DETAILS & ISOMETRIC
A2.1 ROOF PLAN	P4.0 PLUMBING SCHEDULES & NOTES
A3.0 ELEVATIONS	
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A5.1 INTERIOR ELEVATIONS	E0.0 ELECTRICAL SYMBOLS, NOTES AND ABBREVIATIONS
A6.0 REFLECTED CEILING PLAN	E01.0 ELECTRICAL DEMOLITION PLAN
A6.0 DOOR SCHEDULE AND DETAILS	E1.0 LIGHTING PLAN
A10.0 SPECIFICATIONS	E2.0 POWER PLAN
A10.1 SPECIFICATIONS	E2.1 MECHANICAL POWER PLAN
A10.2 SPECIFICATIONS	E3.0 SYSTEM PLAN
A10.3 SPECIFICATIONS - STREETS ADDED	E4.0 PANEL SCHEDULES
F2.0 FURNITURE PLAN	
I2.0 INTERIOR FINISH PLAN	
STRUCTURAL	
S1.0 GSN AND DETAILS	
S2.0 ROOF RAISING AND FOUNDATION DETAILS	



A4 VICINITY MAP
N.T.S.

B4 LOCATION MAP
N.T.S.

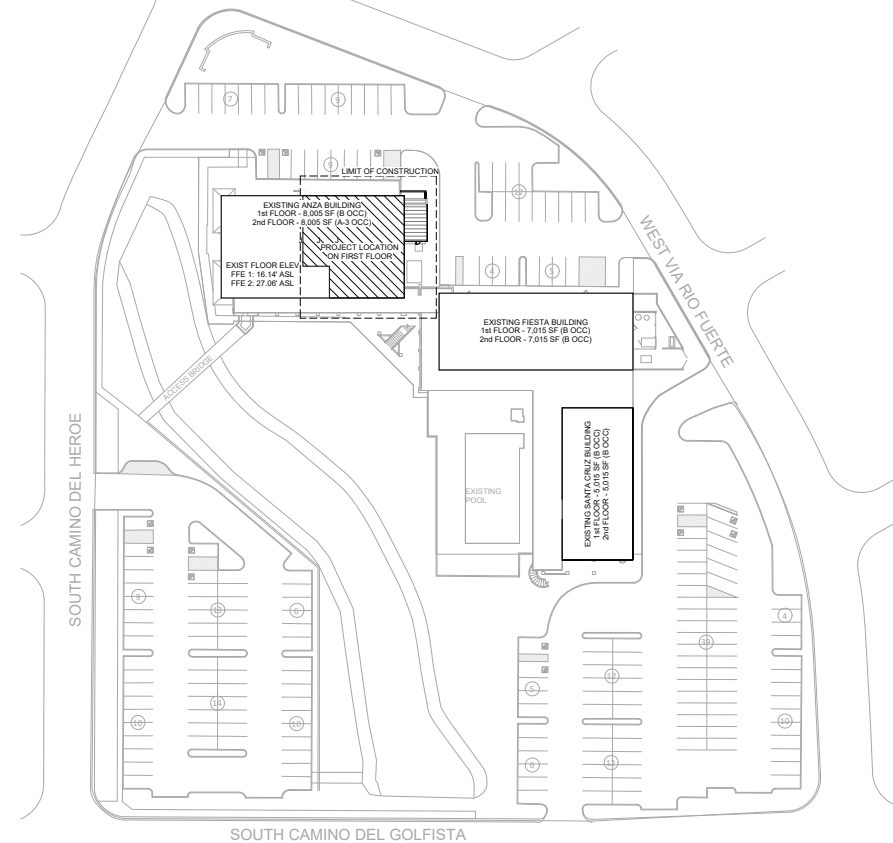

1 SITE PLAN
1" = 40'-0"



Glass Arts TI at Santa Rita Springs

REVISIONS	DATE	BY	DESCRIPTION
1	11/16/2023	TUTSLEY	VALUE ENGINEERING

ISSUE DATE: 11-16-2023

A0.0

WSM ARCHITECTS
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4330 N CAMPBELL AVE, SUITE 268
TUCSON, AZ 85718
520.408.1004 | WWW.WSMARCH.COM



Green Valley Recreation
921 W Via Rio Fuerte, Green Valley, AZ 85614

PROJECT NUMBER: 217230180



NO.	DATE	BY	REVISIONS

DRAWN BY	WSMTEAM
APPROVED BY	RD
ISSUE DATE	11/16/2023
PROJECT NUMBER	217203100

PROJECT CODE SUMMARY

PROJECT NAME: GLASS ARTS T1 AT SANTA RITA SPRINGS

PROJECT ADDRESS: 921 W VIA RIO FUERTE, GREEN VALLEY, AZ 85614

JURISDICTION: GREEN VALLEY

PARCEL: 30419270

LEGAL DESCRIPTION: ROADHAVEN RESORTS INC OF GREEN VALLEY P/TN COMMON AREA B RECREATION AREA 34 105 132

SECTION, TOWNSHIP, RANGE: 34 105 132

ZONING: CMH-2

PROJECT TYPE: TENANT IMPROVEMENT

PROJECT SUMMARY: INTERIOR RENOVATION OF EXISTING COMPUTER CLUB SPACE INTO A NEW CRAFT STUDIO AND KILL ROOM FOR GLASS ARTISTS. THE PROJECT INCLUDES A NEW ~400 SF WORK AREA.

APPLICABLE CODES:

INTERNATIONAL BUILDING CODES
(IBC) INTERNATIONAL BUILDING CODE 2018
(IEBC) INTERNATIONAL EXISTING BUILDING CODE 2018
(IECC) INTERNATIONAL ENERGY CONSERVATION CODE 2018
(IFC) INTERNATIONAL FIRE CODE 2018
(IFGC) INTERNATIONAL FUEL GAS CODE 2018
(IMC) INTERNATIONAL MECHANICAL CODE 2018
(IPC) INTERNATIONAL PLUMBING CODE 2018
(INEC) NATIONAL ELECTRICAL CODE 2017

ACCESSIBILITY GUIDELINES

ICC ACCESSIBLE AND USABLE BUILDINGS AND FACILITIES 2009 A117.1
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ADDITIONAL GUIDELINES

ORD CITY OF TUCSON/PIMA COUNTY OUTDOOR LIGHTING 2012 10983
ORD LOCAL AMENDMENTS TO THE BUILDING CODES 2019 11580

CODE NARRATIVE

CONSTRUCTION TYPE: IB
OCCUPANCY TYPE: B
ACCESSORY USES: NONE

ALLOWABLE BUILDING HEIGHT: 34 FEET
ACTUAL BUILDING HEIGHT: 33 FEET
ALLOWABLE NUMBER OF STORES: 2
ACTUAL NUMBER OF STORES: 2

TABULAR AREA PER STORY (AG): 103718 SF
AREA INCREASE FACTOR (IF): 0.75
AREA INCREASE FACTOR (I): 0
ALLOWABLE AREA PER STORY (AA): 181507 SF
MULTIPLIER FOR STORES ABOVE GRADE PLANE: 2
TOTAL ALLOWABLE BUILDING AREA: 363013 SF
(As Multiplied)

(REFER TO AREA EQUATIONS ON THIS SHEET FOR EQUATIONS USED)

CHAPTER 3 - USE AND OCCUPANCY CLASSIFICATION SUMMARY
THE PRIMARY OCCUPANCY GROUP IS B AND A OCCUPANCIES. THE A OCCUPANCY IS THE BALLROOM ON THE SECOND FLOOR LOCATED ABOVE THIS PROJECT.

CHAPTER 4 - SPECIAL DETAILED REQUIREMENTS BASED ON OCCUPANCY
THIS SECTION IS NOT APPLICABLE. THERE ARE NO SPECIAL USES OR OCCUPANCIES IN THIS WORK.

CHAPTER 5 - GENERAL BUILDING HEIGHTS AND AREAS
THE EXISTING 3 BUILDING ARE TO BE CONSIDERED ONE BUILDING ON SITE. THIS PROJECT IS AN TENANT IMPROVEMENT PUTTING THE GLASS ARTS CLUB IN A VACATED CLUB SPACE. THERE IS NO INCREASE TO THE BUILDING HEIGHT. THIS PROJECT DOES INCLUDE A NEW PATIO. 2ND FLOOR OF BUILDING IS A COMMUNITY CENTER AS OCC AND AN EXISTING 1 HOUR FIRE SEPARATION IS TO BE MAINTAINED.

EXISTING BUILDING IS 40,070 SF. 32,065 SF IS OCC B AND 8,005 IS OCC A-3.

CHAPTER 6 - TYPES OF CONSTRUCTION
THE CONSTRUCTION IS TYPE IB.

CHAPTER 7 - FIRE-RESISTANCE-RATED CONSTRUCTION
THERE ARE NO SPECIAL USES OR OCCUPANCIES IN THIS WORK.

CHAPTER 8 - INTERIOR FINISHES
ALL INTERIOR FINISHES TO BE CLASS 'C' PER TABLE 803.13

CHAPTER 9 - FIRE PROTECTION SYSTEMS
BUILDING IS EQUIPPED WITH A SPRINKLER SYSTEM AND WILL HAVE FIRE EXTINGUISHERS INSTALLED.

CHAPTER 10 - MEANS OF EGRESS
REFER TO THE CODE REVIEW PLAN FOR INFORMATION ABOUT OCCUPANCY LOADS, AND LENGTHS OF PATHS OF TRAVEL, INCLUDING COMMON PATHS OF EGRESS PER TABLE 1006.2.1. COMMON PATHS OF EGRESS SHALL NOT EXCEED 100' PER TABLE FOR F OCCUPANCY. SPACES WITH MORE THAN 49 OCCUPANTS REQUIRES TWO MEANS OF EGRESS PER TABLE 1006.2.1 AND DOORS IN THOSE SPACES SHALL BE SEPARATED BY A DISTANCE NOT LESS THAN 10 FEET OF THE DIAGONAL LENGTH OF THE SPACE PER SECTION 1007.1.1 EXCEPTION 2. EXIT SIGNS SHALL BE PROVIDED IN ACCORDANCE WITH SECTION 1013. EXIT SIGNS SHOWN ON SHEET 1A0.1. SEE ELECTRICAL FOR ADDITIONAL INFORMATION. EXIT ACCESS TRAVEL DISTANCE SHALL NOT EXCEED 250 FEET PER TABLE 1017.2. SEE CODE REVIEW PLAN.

CHAPTER 11 - ACCESSIBILITY

PER SECTION 1103.2.2 EMPLOYEE WORK AREAS DO NOT NEED TO BE ACCESSIBLE. EXCEPT THAT COMMON USE CIRCULATION PATHS WITH THOSE AREAS SHALL BE ACCESSIBLE PER SECTION 1104.3.1. EMPLOYEE WORK AREAS INCLUDE ALL MECHANICAL, ELECTRICAL AND COMMUNICATIONS ROOMS. ALL DOORS INCLUDING THOSE INTO EMPLOYEE WORK AREAS, SHALL HAVE CLEAR FLOOR AREA IN ACCORDANCE WITH ANSI A117.1 SECTIONS 304 AND 305. SINKS HAVE BEEN DESIGNED TO BE ACCESSIBLE.

CHAPTER 12 - INTERIOR ENVIRONMENT

MECHANICAL VENTILATION PER SECTION 1202 IN ACCORDANCE WITH THE MECHANICAL AND ELECTRICAL LIGHTING PER SECTION 1204 SHALL BE PROVIDED.

CHAPTER 13 - ENERGY EFFICIENCY

WORK IN THIS PROJECT SHALL BE DESIGNED TO MEET THE PERFORMANCE REQUIREMENTS OF THE 2018 IECC.

CHAPTER 29 - PLUMBING SYSTEMS

PLUMBING FIXTURES TO BE PROVIDED IN ACCORDANCE WITH THE CODE.

PROJECT CODE SUMMARY SYMBOLS

- ITEM NOT SELECTED
- ITEM SELECTED

BUILDING CLASSIFICATION:
OCCUPANCY CLASSIFICATION AND CONSTRUCTION TYPES PER IBC CHAPTERS 3, 4, 5, AND 6

BASIC OCCUPANCY GROUPS (PER IBC CHAPTER 3)

○ GROUP A-1	○ GROUP A-2	● GROUP A-3
○ GROUP A-4	○ GROUP A-5	● GROUP B
○ GROUP F	○ GROUP F-1	○ GROUP F-2
○ GROUP H-1	○ GROUP H-2	○ GROUP H-3
○ GROUP H-4	○ GROUP H-5	○ GROUP H-6
○ GROUP I-1	○ GROUP I-2	○ GROUP I-3
○ GROUP M	○ GROUP M-1	○ GROUP M-2
○ GROUP P-1	○ GROUP P-2	○ GROUP P-3
○ GROUP P-4	○ GROUP P-5	○ GROUP P-6
○ GROUP S-1	○ GROUP S-2	○ GROUP U

MIXED USE OCCUPANCY (PER IBC SECTION 508 & 509)

- ACCESSORY OCCUPANCIES (IBC 508.2)
- OCCUPANCIES <10% OF STORY (Accessory Occupancies <10% of Story)
- INCIDENTAL USES (IBC SECTION 509)
- NONSEPARATED OCCUPANCIES (IBC 508.3)
- SEPARATED OCCUPANCIES (IBC 508.4)

***REFER TO FIRE AND CODE PLAN FOR SEPARATION REQUIREMENTS**

TYPES OF CONSTRUCTION: TYPE I: ○ A ● B
TYPE II: ○ A ● B
TYPE III: ○ A ● B
TYPE IV: ○ A ● B
TYPE V: ○ A ● B

SPECIAL DETAILED REQUIREMENTS:

- HIGHRISE BUILDING (PER IBC SECTION 403)
- PATRIUM (PER IBC SECTION 404)
- OPEN PARKING GARAGE (PER IBC SECTION 406.5)
- GROUP V-2 (PER IBC SECTION 407)
- SMOKE COMPARTMENTS
- REFUGIA AREA
- HAZARDOUS MATERIALS (PER IBC SECTION 414)
- CONTROL AREAS
- MEZZANINE (PER IBC SECTION 505.2)
- EQUIPMENT PLATFORM (PER IBC SECTION 505.3)

BUILDING AREA CALCULATIONS:

- UNLIMITED AREA ALLOWED (PER IBC TABLE 504.3)
- UNLIMITED HEIGHT ALLOWED (PER IBC TABLE 504.3)
- UNLIMITED AREA BUILDING (PER IBC SECTION 507)
- NONSPRINKLERED, ONE-STORY 60 FOOT WARD SPRINKLERED, ONE-STORY ABOVE GRADE PLANE, 60 YARDS SPRINKLERED, TWO STORES ABOVE GRADE PLANE, 60 YARDS
- AUTOMATIC SPRINKLER SYSTEM INCREASE USED FOR ALLOWABLE HEIGHT MODIFICATION (PER IBC 507.4)
- NO ALLOWABLE HEIGHT OR AREA MODIFICATIONS USED
- ALLOWABLE AREA MODIFICATIONS USED PER THE ALLOWABLE AREA CALCULATIONS ON THIS SHEET.
- BUILDING AREA MODIFICATIONS (PER IBC EQUATION 5-1, 5-2, 5-3) FRONTAGE INCREASE (PER IBC EQUATION 5-4)

MINIMUM FIRE-RESISTANCE REQUIREMENTS:

FIRE-RESISTIVE RATING REQUIREMENTS FOR BUILDING ELEMENTS:

(PER IBC TABLE 601)

TYPE OF CONSTRUCTION: IB

PRIMARY STRUCTURAL FRAME: 0 HOURS
BEARING WALLS (EXT): 0 HOURS
BEARING WALLS (INT): 0 HOURS
NON-BEARING WALLS AND PARTITIONS (EXT): 0 HOURS
PER IBC TABLE 602
FLOOR CONSTR AND PARTITIONS (INTR): 0 HOURS
FLOOR CONSTR AND SECONDARY MEMBERS: 0 HOURS
ROOF CONSTR AND SECONDARY MEMBERS: 0 HOURS

FIRE-RESISTANCE RATING FOR EXTERIOR WALL OPENINGS BASED ON FIRE SEPARATION DISTANCE (X) (PER IBC TABLE 602)

CONSTRUCTION TYPE / OCCUPANCY	BUILDING HEIGHT	1 HOUR	2 HOUR
X < 5 FT	1 HOUR		
5 FT < X < 10 FT	1 HOUR		
10 FT < X < 30 FT	0 HOURS		
X > 30 FT	0 HOURS		

MAXIMUM AREA OF EXTERIOR WALL OPENINGS BASED ON FIRE SEPARATION DISTANCE: PER IBC TABLE 705.8

FIRE SEPARATION DISTANCE (D) (PER IBC TABLE 705.8)

CONSTRUCTION TYPE / OCCUPANCY	BUILDING HEIGHT	1 HOUR	2 HOUR
0 < 3 FT	NP	NP	NP
3 < 5 FT	NP	15%	15%
5 < 10 FT	10%	20%	20%
10 < 15 FT	15%	45%	45%
15 < 20 FT	25%	70%	70%
20 < 25 FT	45%	NL	NL
25 < 30 FT	70%	NL	NL
30 FT >	NL	NL	NL

ADDITIONAL FIRE-RESISTIVE RATINGS:

DESCRIPTION	CODE SECTION	RATING (HR)
SHAFT ENCLOSURES	713	2
FOUR STORES OR MORE: LESS THAN FOUR STORES:	713	1
EXIT ENCLOSURES		
FOUR STORES OR MORE: LESS THAN FOUR STORES:		
EXIT PASSAGEWAYS	1024	1
HOISTWAY ENCLOSURES	707	2
ELEVATOR MACHINE ROOMS	3005	2
CORRIDORS: PER 708	SPRINKLERED	0
OCCUPANCY: B	OCC LOAD SERVED: >30	RATING (HR): 2

OPENING FIRE PROTECTION ASSEMBLIES, RATING AND MARKINGS TO BE PER CHAPTER 7

LIFE SAFETY SYSTEMS:

(PER IBC AND FC CHAPTER 9)

AUTOMATIC SPRINKLER SYSTEM: PROVIDED PER NFPA 13

ALTERNATIVE AUTOMATIC EXTINGUISHING SYSTEMS: PROVIDED - REFER TO PROTECTION DRAWINGS

STANDPIPE SYSTEM: PROVIDED PER NFPA 14: CLASS 1

PORTABLE FIRE EXTINGUISHERS: PROVIDED PER NFPA 10

FIRE ALARM SYSTEM: PROVIDED PER NFPA 72

REQUIRED

OCCUPANTS: 506	(253 MALE 253 FEMALE)
OCCUPANCY: ASSEMBLY - A-2 (RESTAURANTS, ETC.)	WATER CLOSET LAVATORIES BATHTUBS OR SHOWERS DRINKING FOUNTAINS OTHER
MALE FEMALE MALE FEMALE	
RATIO: 1.75 1.75 1.200 1.200	1.500
REQUIRED: 3.37 3.37 1.27 1.27	1.01 NOTE 1

REQUIRED

OCCUPANTS: 213	(107 MALE 107 FEMALE)
OCCUPANCY: BUSINESS - B	WATER CLOSET LAVATORIES BATHTUBS OR SHOWERS DRINKING FOUNTAINS OTHER
MALE FEMALE MALE FEMALE	
RATIO: 1.25 FIRST 50 1.40 FIRST 80 1.50 REMAIN	1.100
REQUIRED: 3.14 3.14 2.34 2.34	2.13 NOTE 1

PROVIDED

OVERALL BUILDING SUMMARY	WATER CLOSET	LAVATORIES	BATHTUBS OR SHOWERS	DRINKING FOUNTAINS	OTHER
MALE FEMALE MALE FEMALE					
SUBTOTAL REQUIRED: 8.00 8.00 5.00 5.00	0	4.00	1	1	1
TOTAL REQUIRED: 8 8 5 5 0 4					
WC PROVIDED: 4 10	--	--	--	--	--
LAV PROVIDED: --	--	8 8	--	--	--
URINALS PROVIDED: 6	--	--	--	--	--
DF PROVIDED: --	--	--	--	0	--
TOTAL PROVIDED: 10 10 8 8 0 0					

SINGLE-OCCUPANT RESTROOMS INCLUDED IN THE ABOVE TOTALS: 1
FAMILY RESTROOMS PROVIDED IN ADDITION TO ABOVE TOTALS: 0
FAMILY BATHING ROOMS PROVIDED IN ADDITION TO ABOVE TOTALS: 0

FUNCTION OF SPACE

ASSEMBLY, WORSHIP, RECREATION, OR AMUSEMENT

SYMBOL LEGEND

FIRE SEPARATION = 1-HOUR RATED

EGRESS COMPONENT CAPACITY SYMBOLS

OCC. GROUP

- 000 SF ← USE GROUP OF SPACE
- AREA OF SPACE
- OLF NSFGSF ← SF PER OCCUPANT
- # OCCUPANTS ← NUMBER OF OCCUPANTS

EGRESS COMPONENT CAPACITY SYMBOLS

- # OF OCCUPANTS EXITING
- MIN. WIDTH OF MEANS OF EGRESS COMPONENTS (IN.)
- EXIT WIDTH PROVIDED (IN.)
- CALCULATED EXIT WIDTH REQUIRED (IN.)

STAIR #1

- # OF OCCUPANTS EXITING
- EGRESS WIDTH REQUIRED
- EGRESS WIDTH PROVIDED

EXITING SYMBOLS

- PATH ID
- COMMON PATH OF EXIT TRAVEL


FIRE PROTECTION SYMBOLS

- FEC = FIRE EXTINGUISHER CABINET
- FE = FIRE EXTINGUISHER
- EXIT SIGNAGE

D4 1ST FLOOR CODE PLAN
3/22" = 1'-0"

AMERICAN DRAFTING SYSTEMS, INC. 2023.01.01
11/16/2023 10:00 AM
11/16/2023 10:00 AM

5

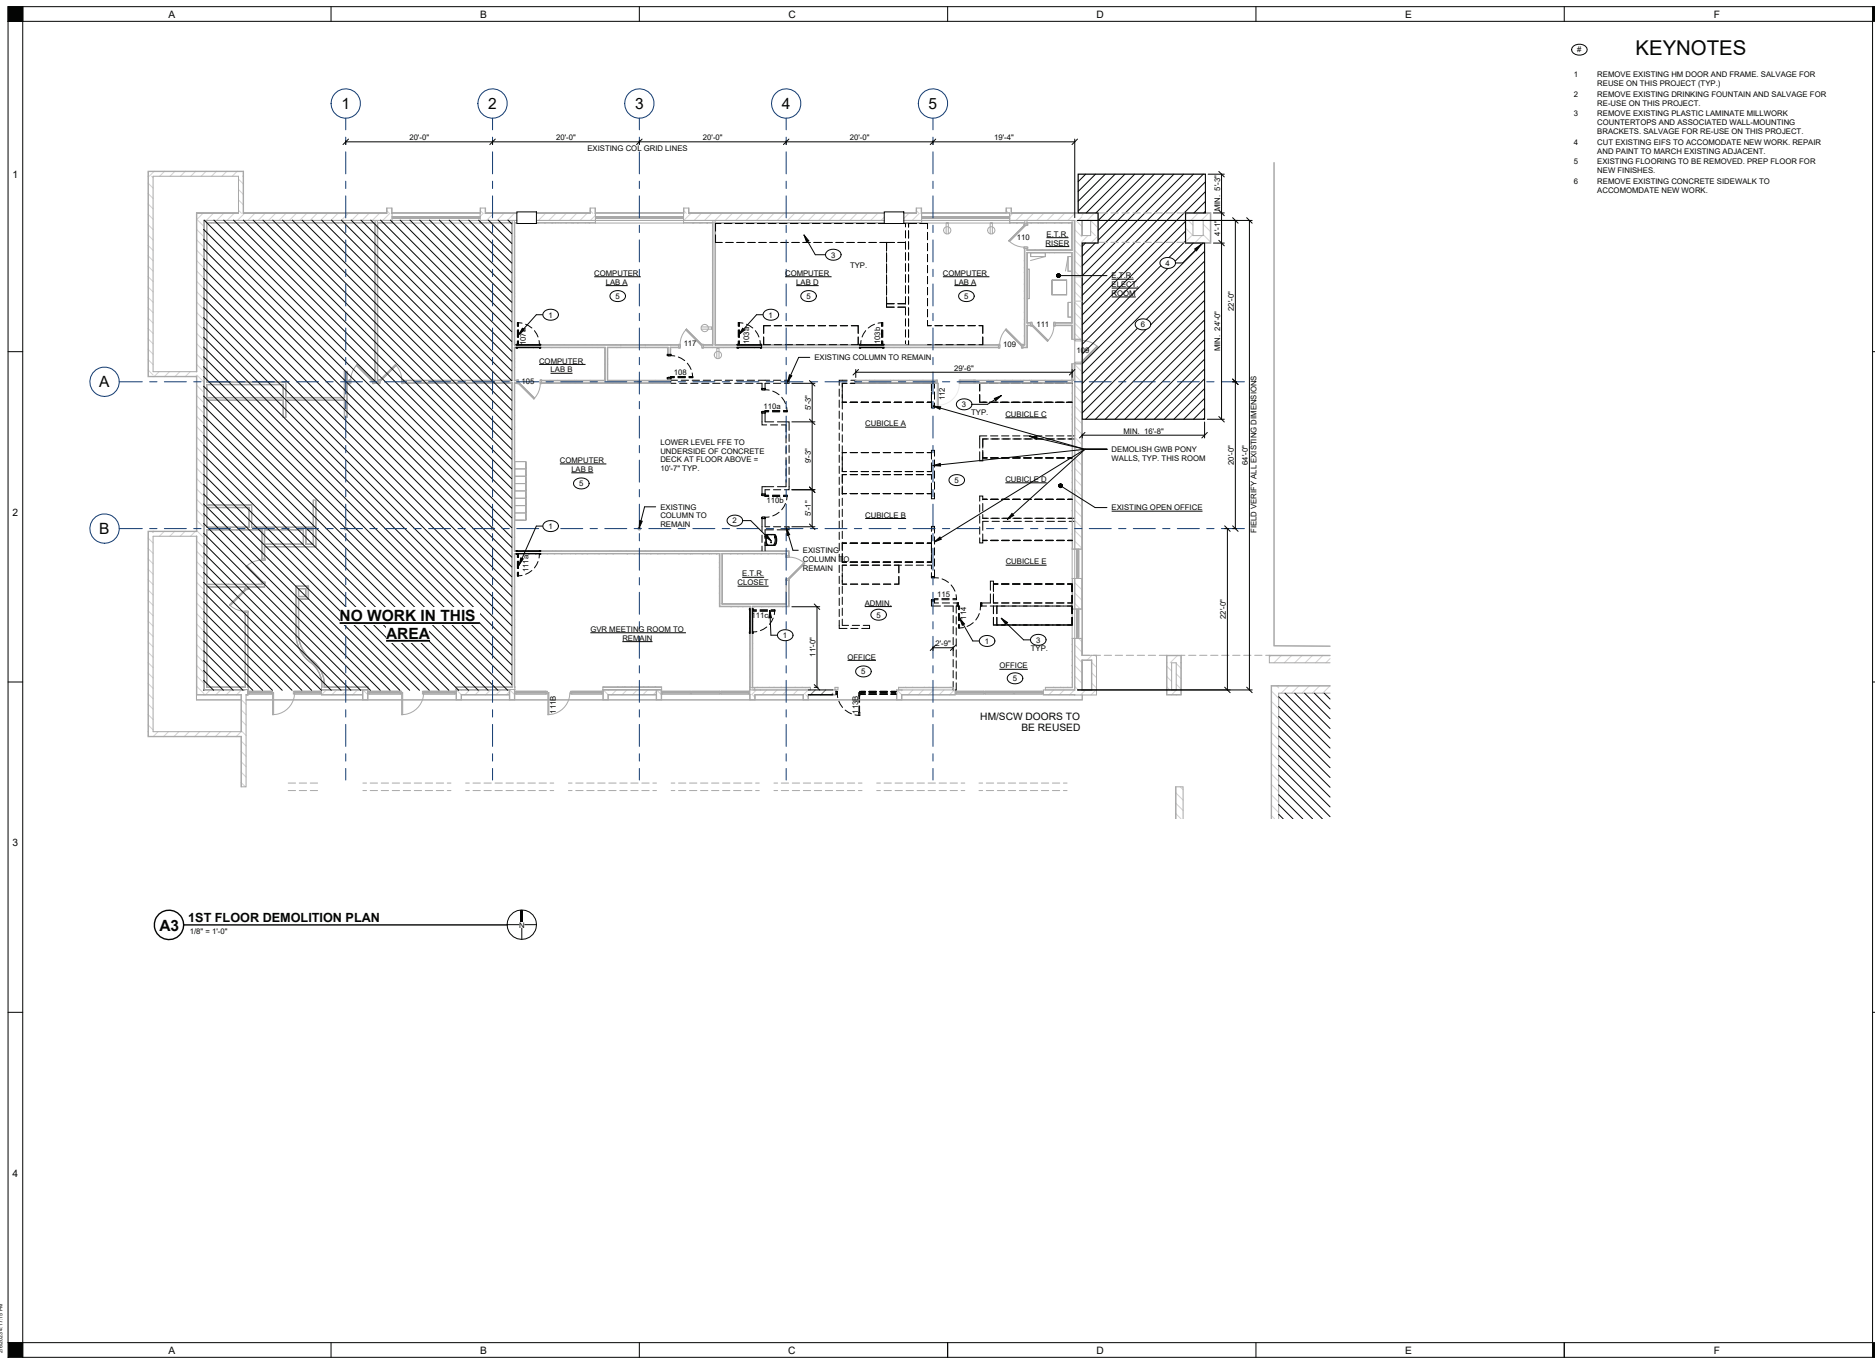

KEYNOTES

- 1 REMOVE EXISTING HM DOOR AND FRAME. SALVAGE FOR REUSE ON THIS PROJECT (TYP.)
- 2 REMOVE EXISTING DRINKING FOUNTAIN AND SALVAGE FOR REUSE ON THIS PROJECT
- 3 REMOVE EXISTING PLASTIC LAMINATE MILLWORK COUNTERTOPS AND ASSOCIATED WALL-MOUNTING BRACKETS. SALVAGE FOR REUSE ON THIS PROJECT.
- 4 CUT EXISTING EPS TO ACCOMMODATE NEW WORK. REPAIR AND PAINT TO MATCH EXISTING ADJACENT.
- 5 EXISTING FLOORING TO BE REMOVED. PREP FLOOR FOR NEW FINISHES.
- 6 REMOVE EXISTING CONCRETE SIDEWALK TO ACCOMMODATE NEW WORK.

A3 1ST FLOOR DEMOLITION PLAN
3/8" = 1'-0"

WSM ARCHITECTS
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Glass Arts TI at Santa Rita Springs

Green Valley Recreation
921 W Via Rio Fuerte, Green Valley, AZ 85614

NO.	DATE	REVISIONS

DRAWN BY:	WSMTEAM
APPROVED BY:	RD
ISSUE DATE:	11/16/2020
PROJECT NUMBER:	21723130

DEMOLITION FLOOR PLAN

D2.0

ARCHITECT: DATE: 11/16/2020 11:53:00 AM
 PROJECT: 21723130
 SHEET: D2.0



NO.	DATE	REVISIONS

DRAWN BY	WSM TEAM
APPROVED BY	
ISSUE DATE	11/16/2023
PROJECT NUMBER	217203100

GENERAL FLOOR PLAN NOTES


- CONTRACTOR IS RESPONSIBLE FOR FIELD VERIFYING ALL QUANTITIES, DIMENSIONS AND EXISTING CONDITIONS AS REQUIRED TO COMPLETE THE CONTRACT. NOTIFY ARCHITECT OF ANY DISCREPANCIES PRIOR TO BID.
- SEE ALL ENGINEERING DRAWINGS FOR ADDITIONAL REQUIREMENTS.
- EXISTING FINISHES TO REMAIN SHALL BE PROTECTED FROM DAMAGE DURING CONSTRUCTION. ANY DAMAGED FINISHES SHALL BE REPAIRED TO LIKE NEW CONDITION.
- PROVIDE FIRE TREATED WOOD BLOCKING IN WALLS OR ALL WALL STOPS, TYP.
- PROVIDE ACCESS PANELS IN WALLS AND GWB CEILING AT VALVES AND JUNCTION BOXES - SEE MECHANICAL, PLUMBING AND ELECTRICAL DRAWINGS FOR EXACT LOCATIONS. PAINT ACCESS PANELS TO MATCH ADJ. SURFACES, TYP.
- CONTRACTOR TO COORDINATE CONSTRUCTION WITH EXISTING EQUIPMENT TO REMAIN. COORDINATE WITH MECHANICAL, PLUMBING AND ELECTRICAL DRAWINGS.
- VERIFY ALL EXISTING BUILDING FINISHED FLOOR ELEVATIONS PRIOR TO START OF WORK AND NOTIFY ARCHITECT OF ANY DISCREPANCIES.

WALL TYPE NOTES

- ALL EXTERIOR PARTITIONS SHALL BE TYPE E1, UNLESS NOTED OTHERWISE ON THE PLANS.
- USE MOISTURE AND MOLD RESISTANT GYPSUM BOARD IN ROOMS SCHEDULED TO RECEIVE CERAMIC WALL TILE, INCLUDING, BUT NOT LIMITED TO TOILET ROOMS.
- ALL OUTSIDE CORNERS OF GYPSUM BOARD PARTITIONS SHALL HAVE METAL CORNER BEADS.
- TERMINATE ALL GYPSUM BOARD EDGES ABUTTING DISSIMILAR MATERIALS AND EDGES EXPOSED TO VIEW, WITH NON-EXPOSED METAL CASING BEAD AND ISOLATED BY BACK ROD AND SEALANT FULL-LENGTH UNLESS OTHERWISE INDICATED.
- REFER TO REFLECTED CEILING PLANS FOR LOCATIONS AND EXTENT OF PARTITIONS SEALED TO THE DECK ABOVE. SEAL ALL Penetrations THROUGH WALLS INTO IT AND MECHANICAL ROOMS.
- ALL FIRE-RATED AND ACOUSTIC-RATED PARTITIONS SHALL EXTEND TO AND CLOSE OFF TO SOLID STRUCTURE ABOVE.
- PROVIDE ACOUSTIC SEALANT AT BASE OF ALL STUD WALLS AND AT PENETRATIONS.
- PROVIDE GYPSUM BOARD ON FOUR SIDES OF OPENINGS FRAMED FOR DAMPERS. USE SAME NUMBER OF LAYERS AND TYPE OF GYPSUM BOARD AS FOR SIDE PARTITION WITH GREATER PROTECTION.
- PROVIDE DEFLECTION TRACK AT ALL WALLS THAT EXTEND TO DECK.
- PROVIDE BRACING FOR ALL INTERIOR PARTITIONS FOR SEISMIC DESIGN CATEGORY "D" PER THE BC.
- PROVIDE STEEL STRAPPING OR FIRE TREATED WOOD BLOCKING IN PARTITIONS FOR WALL HUNG ITEMS INCLUDING CASEWORK, SHELVING AND EQUIPMENT.
- PROVIDE CONTROL JOINTS IN PARTITIONS AS INDICATED.
- PARTITION STUD FRAMING GAUGE, HEIGHT, AND SPACING SHALL BE AS FOLLOWS
- SEE STRUCTURAL DRAWINGS FOR SHEAR AND BEARING WALLS.
- SEE STRUCTURAL DRAWINGS FOR CONCRETE AND MASONRY WALL REINFORCING.
- PROVIDE CONTINUOUS FIRE TREATED PLYWOOD BLOCKING IN BATHROOMS TO 5'-0" A.F.F. FOR GRAB BARS AND ACCESSIBLE FUTURE MOUNTING.
- INTERIOR STEEL STUDS SHALL NOT BE LESS THAN 2" GAUGE AND NOT MORE THAN 1'-4" ON CENTER UNLESS OTHERWISE INDICATED. 20 GAUGE STUDS MINIMUM SHALL BE USED TO FRAME ALL DOORS, BORROWED LIGHT, PASS-THRU AND CASSED OPENINGS. SEE SPECIFICATIONS FOR DESIGN AND ENGINEERING.
- PROVIDE DOUBLE STUDS AT EACH SIDE OF OPENINGS. EXTEND STUDS FROM FLOOR TO UNDERSIDE OF STRUCTURE ABOVE.
- MAINTAIN CONTINUITY OF FIRE-RATED PARTITIONS AT INTERSECTIONS WITH NON-RATED OR LESSER RATED PARTITIONS.
- PROVIDE BRACING, AS RECOMMENDED BY STUD MANUFACTURER, AT ALL CHASE WALLS.
- DIMENSIONS OF GYPSUM BOARD AND METAL STUD PARTITIONS ON THE FLOOR PLANS IS TO THE FINISHED FACE OF THE SURFACE UNLESS OTHERWISE INDICATED.
- PROVIDE ACCESS PANELS AT ALL VALVES AND JUNCTION BOXES IN WALLS AND GWB CEILING. COORDINATE LOCATION W/ ARCHITECT PRIOR TO INSTALLATION. PAINT TO MATCH ADJACENT SURFACES.
- ALL CONFERENCE ROOMS, PRIVATE OFFICES, AND TOILET ROOMS SHALL HAVE SOUND ATTENUATING FIBERGLASS BATT INSULATION IN WALLS.
- PROVIDE CONCRETE BACKER BOARD FOR CERAMIC TILE IN LIEU OF MOISTURE-RESISTANT GYPSUM BOARD AT SHOWER WALLS.
- DIMENSIONING IN PLAN OF ALL MASONRY PARTITIONS AND OTHER MASONRY ELEMENTS IS TO THE FACE OF MASONRY.


KEYNOTES

- NEW STAINLESS STEEL SINK
- EXISTING COLUMN TO REMAIN, PAINT
- NEW 8" HIGH 8" CMU WALL WITH STUCCO FINISH
- NEW METAL GATE, PAINTED.
- NEW 1/2" WHITE MELAMINE SHELVES, 12" DEEP, ON HEAVY-DUTY SHELVING STANDARD BRACKETS
- INFILL PORTION OF EXISTING PARTITION WALL AND FINISH TO MATCH EXISTING ADJACENT FINISHES
- PLASTIC LAMINATE MILLWORK UPPER CABINET, 12" DEEP
- WALL MOUNTED DRY ERASE MARKER BOARD, 0.F.O.I.
- WALL MOUNTED LAMINATE COUNTERTOP TO BE 2" A.F.F.
- WALL MOUNTED LAMINATE COUNTERTOP TO BE 3" A.F.F.
- NEW CONCRETE AT DOOR TO BE A DESIGNED TO HAVE 1 1/2" SLOPE BOTH DIRECTIONS AND NOT BE MORE THAN 1/4" ELEVATION CHANGE AT THRESHOLD.

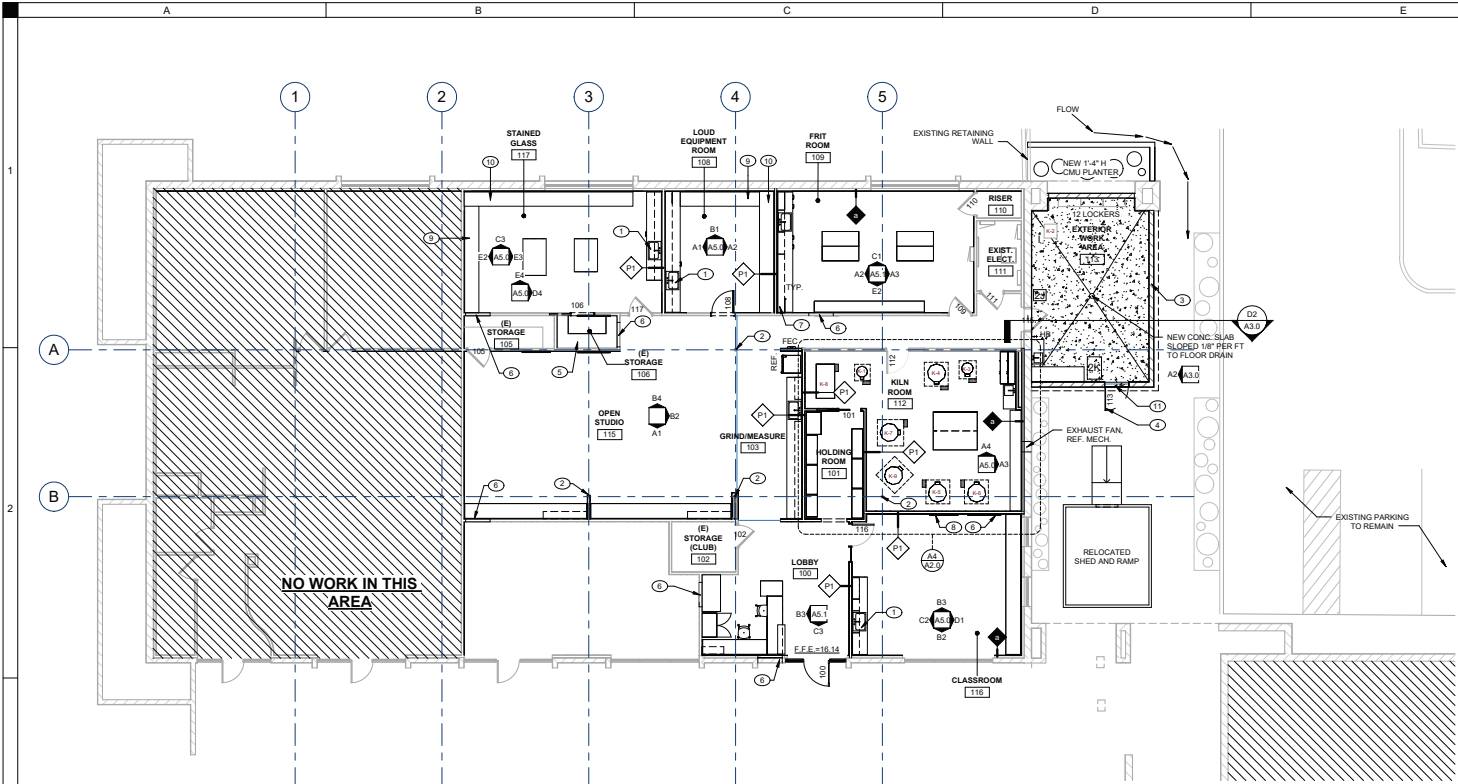

NO WORK IN THIS AREA

A3 FLOOR PLAN
1/8" = 1'-0"

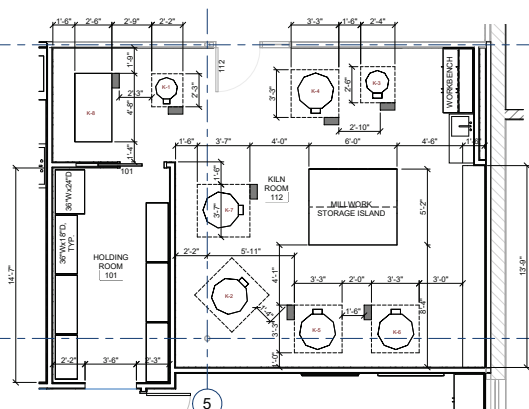


A4 ENLARGED PLAN RM. 112
1/4" = 1'-0"

EQUIPMENT LIST
(CLUB PROVIDED/ CLUB INSTALLED)

- K-1 EXISTING AIM 1110 KILN TO BE RELOCATED TO THE KILN ROOM
- K-2 RELOCATED AIM WRITER/GRAPH KILN TO COVERED PORCH
- K-3 EXISTING JEN KEN AF3P KILN TO BE RELOCATED TO THE KILN ROOM
- K-4 EXISTING PARAGON GT1080 KILN TO BE RELOCATED TO THE KILN ROOM
- K-5 EXISTING SKUTT 1014 KILN TO BE RELOCATED TO THE KILN ROOM
- K-6 EXISTING SKUTT 1027A KILN TO BE RELOCATED TO THE KILN ROOM
- K-7 EXISTING SKUTT 1027B KILN TO BE RELOCATED TO THE KILN ROOM
- K-8 NEW Q15 41 KILN TO BE INSTALLED IN THE KILN ROOM
- K-9 NEW SP 28 KILN TO BE INSTALLED IN THE KILN ROOM
- K-10 NEW CALIFORNIA TOOLS AIR COMPRESSOR MODEL # CAT-4620AC - EXT. WORK AREA
- K-11 NEW HOMAK VERTICAL ABRASIVE BLASTING CABINET MODEL #RD00542380 - EXT. WORK AREA

WALL TYPES AND SUBTYPES

MARK	DESCRIPTION	PLAN DETAIL
M1	8"x16" CMU BLOCK	
P1	5/8" GYPSUM BOARD (EXTEND 6" PAST CEILING U.N.O.) 3/8" 25 GA. STEEL STUDS @ 1'-4" O.C. WITH BATT INSULATION 5/8" GYPSUM BOARD (EXTEND 6" PAST CEILING U.N.O.)	
P2	5/8" GYPSUM BOARD TO DECK 6" 18 GA. STEEL STUDS @ 1'-4" O.C. WITH BATT INSULATION 5/8" GYPSUM BOARD TO DECK	
a	CONCRETE TILT WALL (SHELL) 3/8" 25 GA. STEEL STUDS @ 1'-4" O.C. WITH R-19 BATT INSULATION 5/8" GYPSUM BOARD (EXTEND TO ROOF DECK) SUBSTITUTE FOR "MagPanel" MAGNESIUM OXIDE SHEATHING IN KILN ROOM	

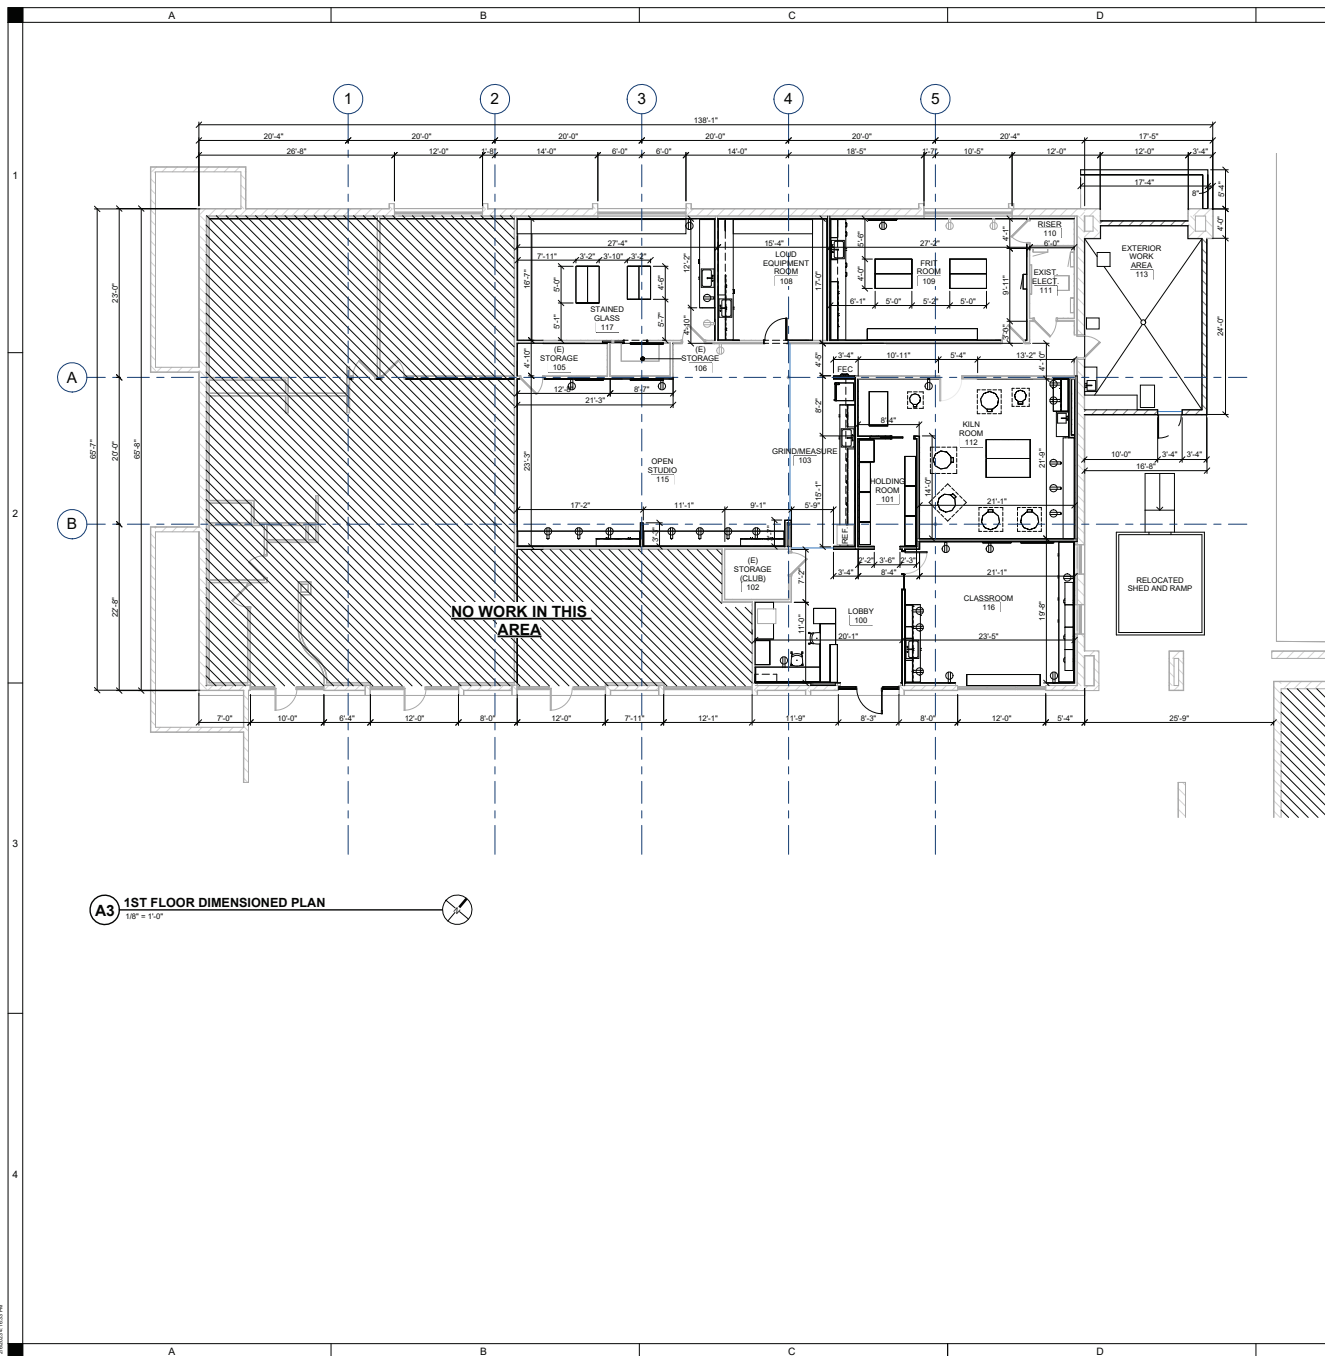

A3 1ST FLOOR DIMENSIONED PLAN
 1/8" = 1'-0"

GENERAL DIMENSION PLAN NOTES

- A. ALL EXTERIOR DIMENSIONS SHOWN ON PLAN ARE TO CENTERLINE OF COLUMN, FACE OF MASONRY OR WOOD STUD AND DO NOT INCLUDE THICKNESS OF DRYWALL UNLESS OTHERWISE NOTED.
- B. ALL INTERIOR DIMENSIONS SHOWN ON PLAN ARE TO FACE OF MASONRY OR TO FINISHED FACE OF STUD PARTITIONS, UNLESS NOTED OTHERWISE.
- C. ALL DIMENSIONS ON ROOM ELEVATIONS ARE TO FACE OF FINISH UNLESS NOTED OTHERWISE.
- D. DO NOT USED SCALED DIMENSIONS. WHERE NO DIMENSION IS PROVIDED, CONSULT ARCHITECT FOR MORE INFORMATION PRIOR TO BEGINNING WORK.
- E. CONTRACTOR TO FIELD VERIFY EXISTING DIMENSIONS AND EXISTING CONDITIONS. MINOR DIFFERENCES IN DIMENSIONS AND CONFIGURATION BETWEEN THESE CONTRACT DOCUMENTS AND ACTUAL FIELD CONDITIONS, AS DEFINED BY THE ARCHITECT, SHALL NOT BE CAUSE FOR CHANGE ORDERS OR ADDITIONAL COMPENSATION.
- F. CONTRACTOR AND SUBCONTRACTORS SHALL VERIFY ALL DIMENSIONS IN THE FILED PRIOR TO BEGINNING CONSTRUCTIONS OR ORDERING ANY MATERIALS.
- G. ANY DISCREPANCIES BETWEEN FIELD CONDITIONS AND PLANS SHALL BE BROUGHT TO THE ATTENTION OF THE ARCHITECT PRIOR TO PROCEEDING WITH THE WORK.
- H. REFER TO INTERIOR ELEVATIONS FOR ADDITIONAL DIMENSIONS.
- I. REFER TO ENLARGED FLOOR PLANS FOR ADDITIONAL DIMENSIONS AS INDICATED ON REFERENCE SHEETS.
- J. REFER TO UNITS SCHEDULES FOR MASONRY OPENINGS. PROVIDE UNITS FOR ALL MECHANICAL AND ELECTRICAL PENETRATIONS IN MASONRY WALLS. PROVIDE GALVANIZED UNITS AT EXTERIOR WALLS AND AS SPECIFIED.

WSM ARCHITECTS
 A DIVISION OF SHIVE-HATTERY
 4001A CAMPBELL AVE., SUITE 208
 GREEN VALLEY, ARIZONA 85614
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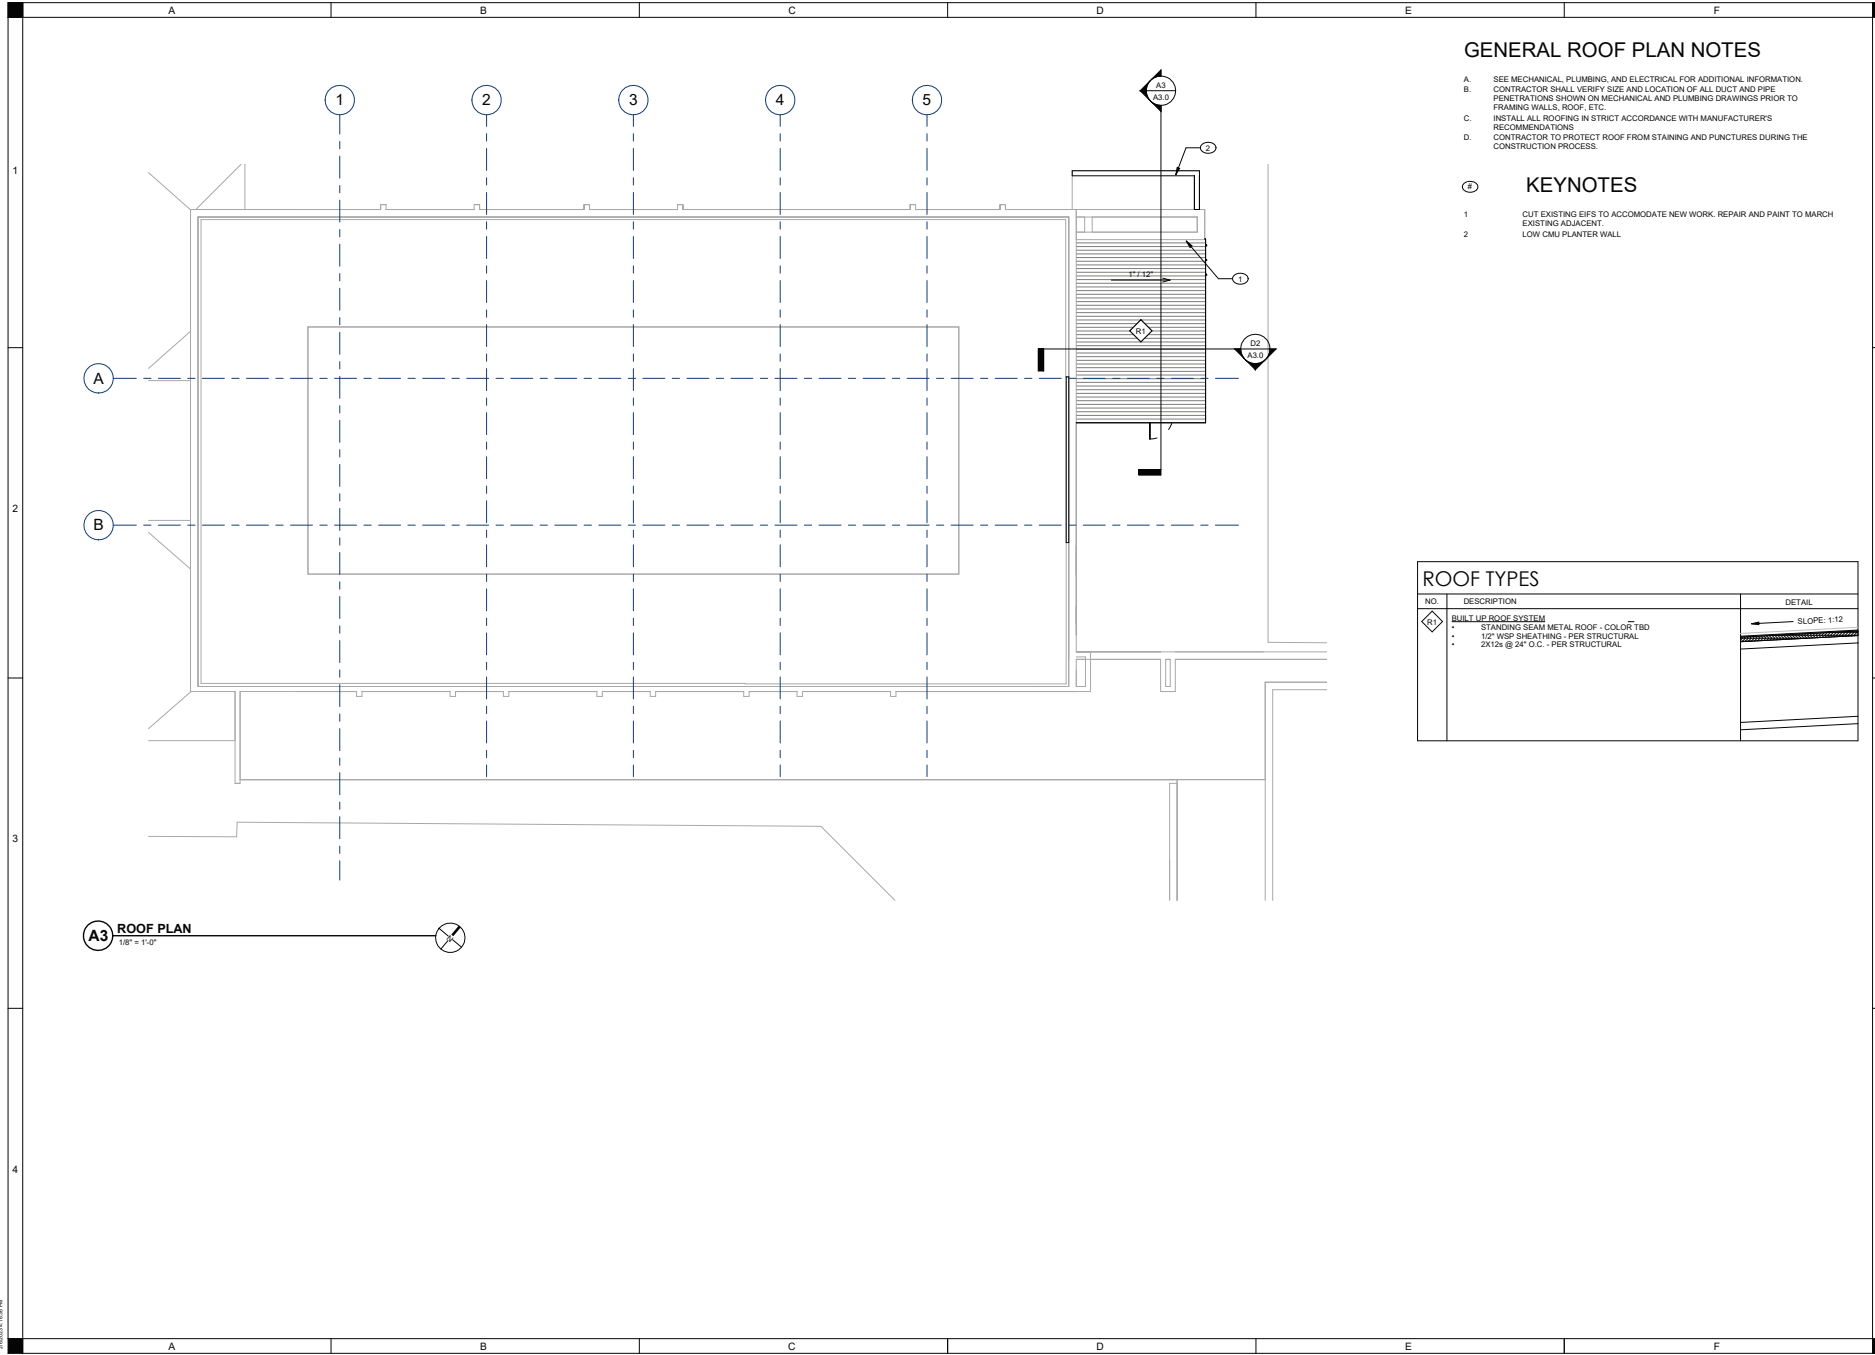
Glass Arts T1 at Santa Rita Springs
 Green Valley Recreation
 921 W Via Rio Fuerte, Green Valley, AZ 85614

REVISIONS	

DRAWN BY	WSMTEAM
APPROVED BY	RD
ISSUE DATE	11-16-2023
PROJECT NUMBER	217230100

DIMENSION PLAN
A2.0D

ARCHITECT: PAUL D. MICKELBERG, P.E.
 ARCHITECT: PAUL D. MICKELBERG, P.E.
 ARCHITECT: PAUL D. MICKELBERG, P.E.



GENERAL ROOF PLAN NOTES

- A. SEE MECHANICAL, PLUMBING, AND ELECTRICAL FOR ADDITIONAL INFORMATION. CONTRACTOR SHALL VERIFY SIZE AND LOCATION OF ALL DUCT AND PIPE PENETRATIONS SHOWN ON MECHANICAL AND PLUMBING DRAWINGS PRIOR TO FRAMING WALLS, ROOF, ETC.
- B. INSTALL ALL ROOFING IN STRICT ACCORDANCE WITH MANUFACTURERS RECOMMENDATIONS
- C. CONTRACTOR TO PROTECT ROOF FROM STAINING AND PUNCTURES DURING THE CONSTRUCTION PROCESS.

KEYNOTES

- 1. CUT EXISTING EIFS TO ACCOMMODATE NEW WORK. REPAIR AND PAINT TO MATCH EXISTING ADJACENT.
- 2. LOW CMU PLANTER WALL

ROOF TYPES		DETAIL
NO.	DESCRIPTION	
A2	BUILT UP ROOF SYSTEM • STANDING SEAM METAL ROOF - COLOR TBD • 1/2" WSP SHEATHING - PER STRUCTURAL • 2X12s @ 24" O.C. - PER STRUCTURAL	SLOPE: 1:12

WSM ARCHITECTS
 A DIVISION OF SHIVE-HATTERY

4001A CAMPBELL LANE, SUITE 208
 920 408 4841 | WSMARCH.COM

PAUL D. MICKELBERG
 LICENSED ARCHITECT
 STATE OF ARIZONA
 LICENSE NO. 15558

Glass Arts T1 at Santa Rita Springs

Green Valley Recreation
 9211 Via Rio Frio, Green Valley, AZ 85614


REVISIONS	
NO.	DESCRIPTION

DRAWN BY	WSMTEAM
APPROVED BY	RD
ISSUE DATE	11/16/2023
PROJECT NUMBER	217203100

ROOF PLAN

A2.1

ARZ0001-0001-01 (2023) 10/16/2023 09:48 AM 10/16/2023
 11/16/2023 11:45:27 AM
 11/16/2023 11:45:27 AM

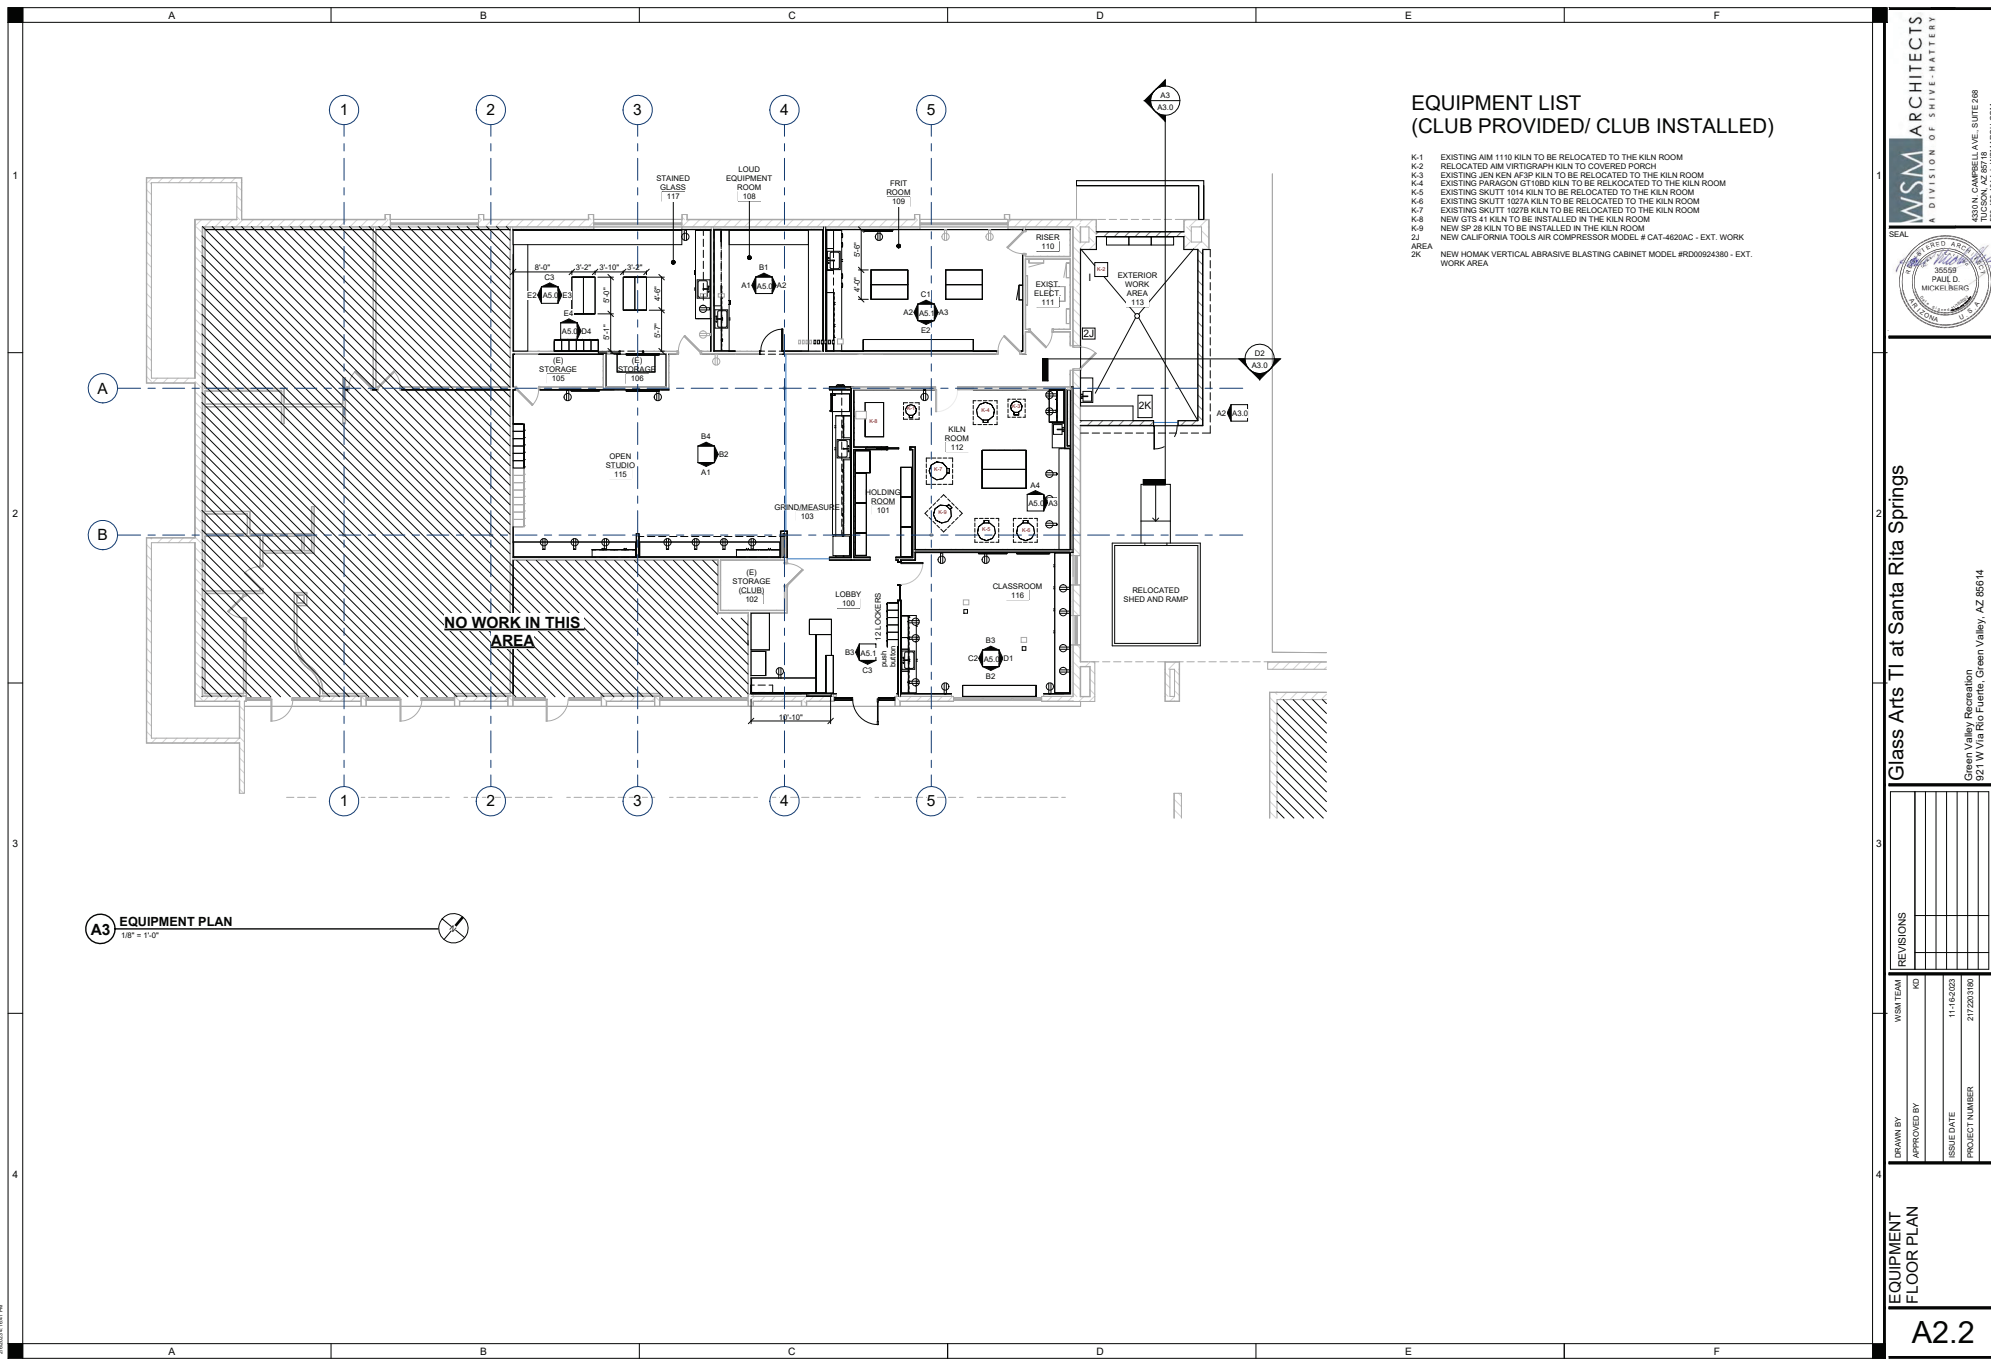

**EQUIPMENT LIST
(CLUB PROVIDED/ CLUB INSTALLED)**

- K-1 EXISTING AM 1110 KILN TO BE RELOCATED TO THE KILN ROOM
- K-2 RELOCATED AIM VIRTIGRAPH KILN TO COVERED PORCH
- K-3 EXISTING JEN KEN A73P KILN TO BE RELOCATED TO THE KILN ROOM
- K-4 EXISTING PARAGON 01180D KILN TO BE RELOCATED TO THE KILN ROOM
- K-5 EXISTING SKUTT 1014 KILN TO BE RELOCATED TO THE KILN ROOM
- K-6 EXISTING SKUTT 1027A KILN TO BE RELOCATED TO THE KILN ROOM
- K-7 EXISTING SKUTT 1027B KILN TO BE RELOCATED TO THE KILN ROOM
- K-8 NEW 075 41 KILN TO BE INSTALLED IN THE KILN ROOM
- K-9 NEW SP 28 KILN TO BE INSTALLED IN THE KILN ROOM
- ZJ NEW CALIFORNIA TOOLS AIR COMPRESSOR MODEL # CAT-4620AC - EXT. WORK AREA
- ZK NEW HOMAK VERTICAL ABRASIVE BLASTING CABINET MODEL #RD00924380 - EXT. WORK AREA

WSM ARCHITECTS
A DIVISION OF SHIVE-HATTERY

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SAN JOSE, CA 95131
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Glass Arts T1 at Santa Rita Springs

Green Valley Recreation
921 W Via Rio Fuerte, Green Valley, AZ 85614


NO.	REVISIONS

DRAWN BY	WSMTEAM
APPROVED BY	RD
ISSUE DATE	11/16/2023
PROJECT NUMBER	217203100

EQUIPMENT FLOOR PLAN

A2.2

ARCHITECT: DATE: 01/20/2024 10:42:00 AM 2024 04/18/2024
 ARCHITECT: 11/16/2023 11:43:00 AM 2023
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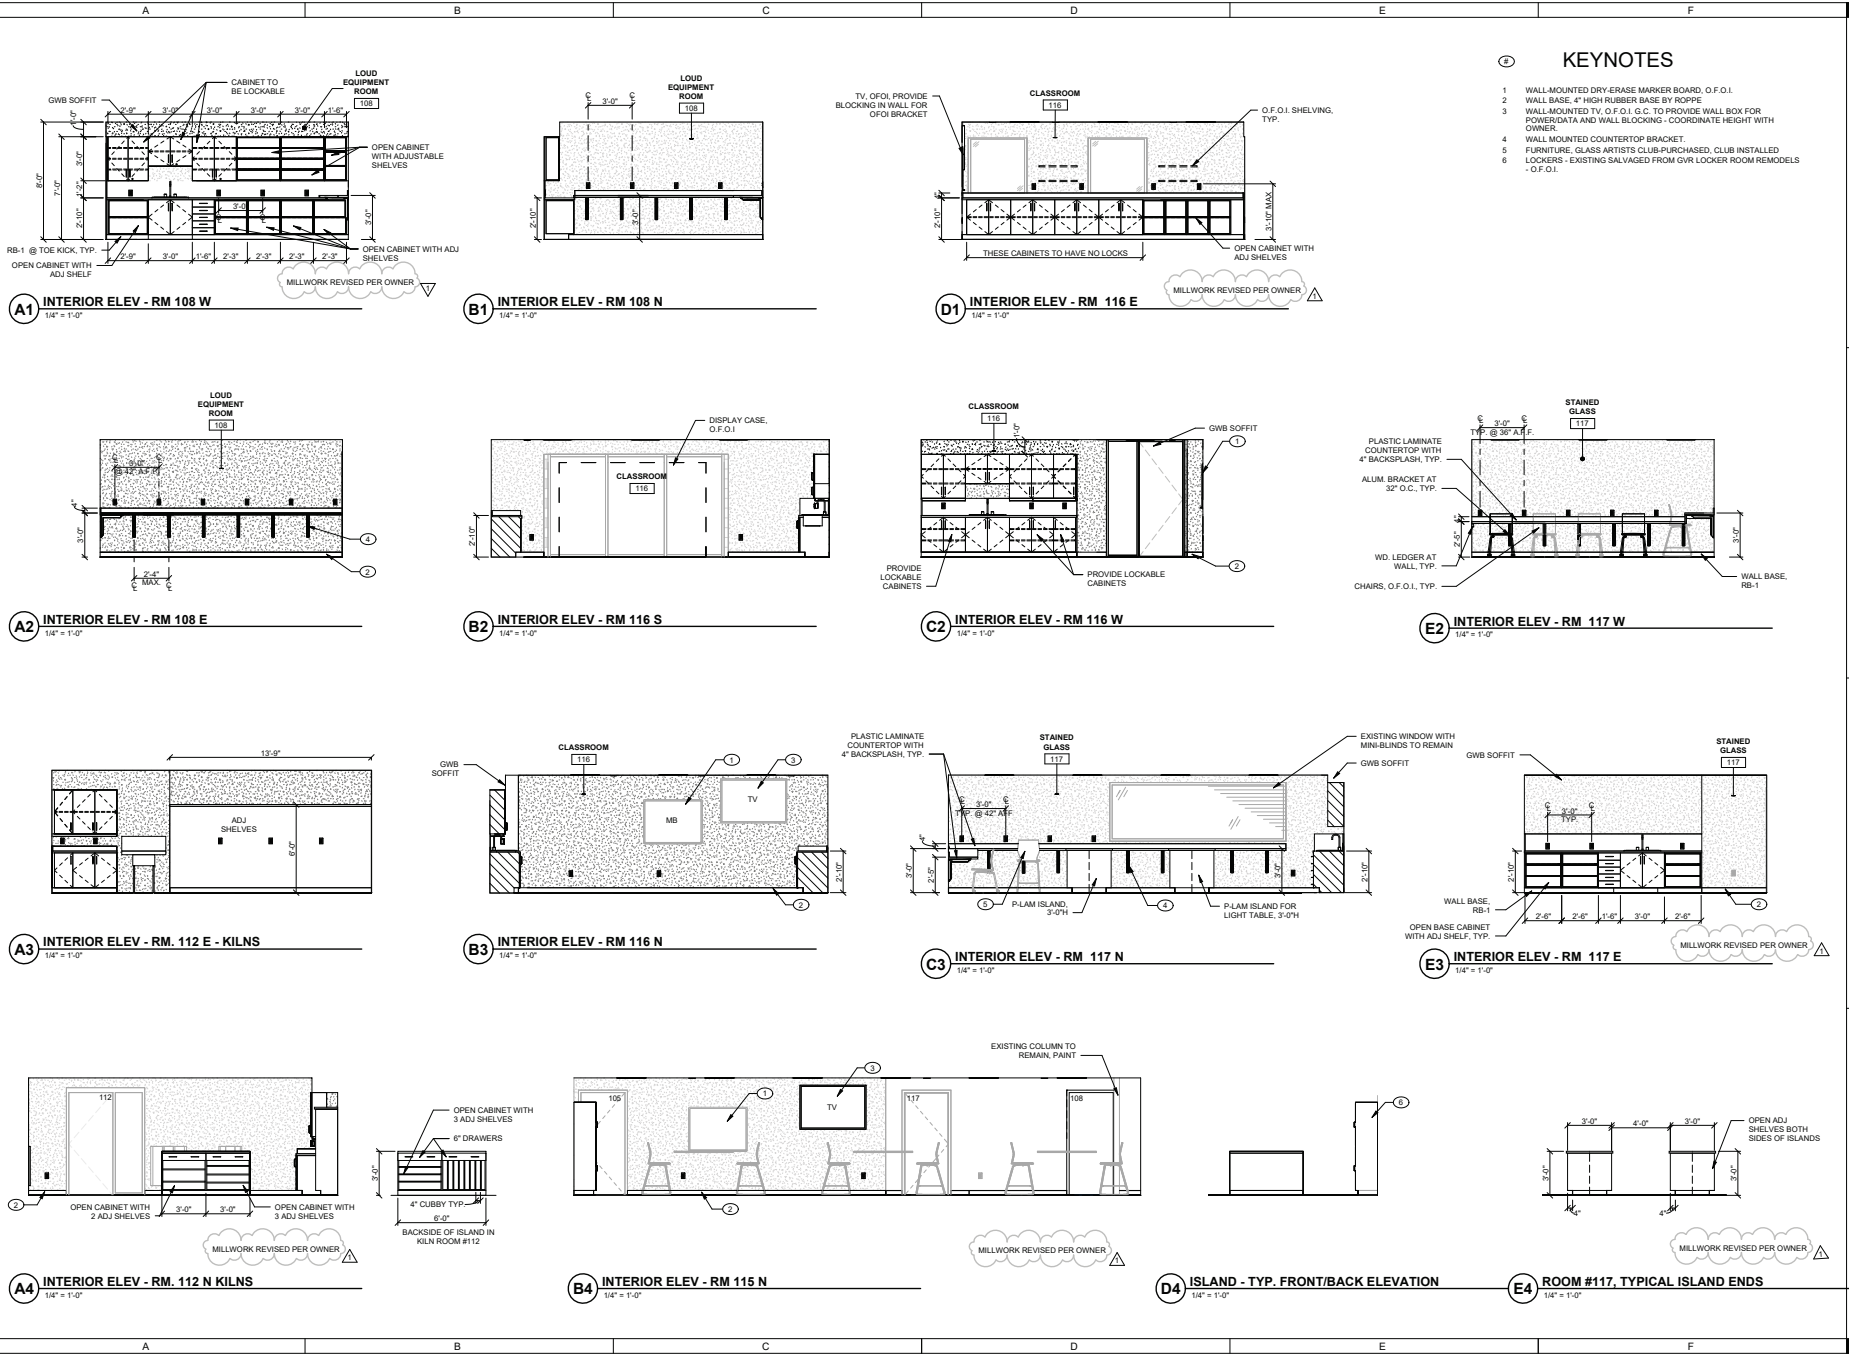


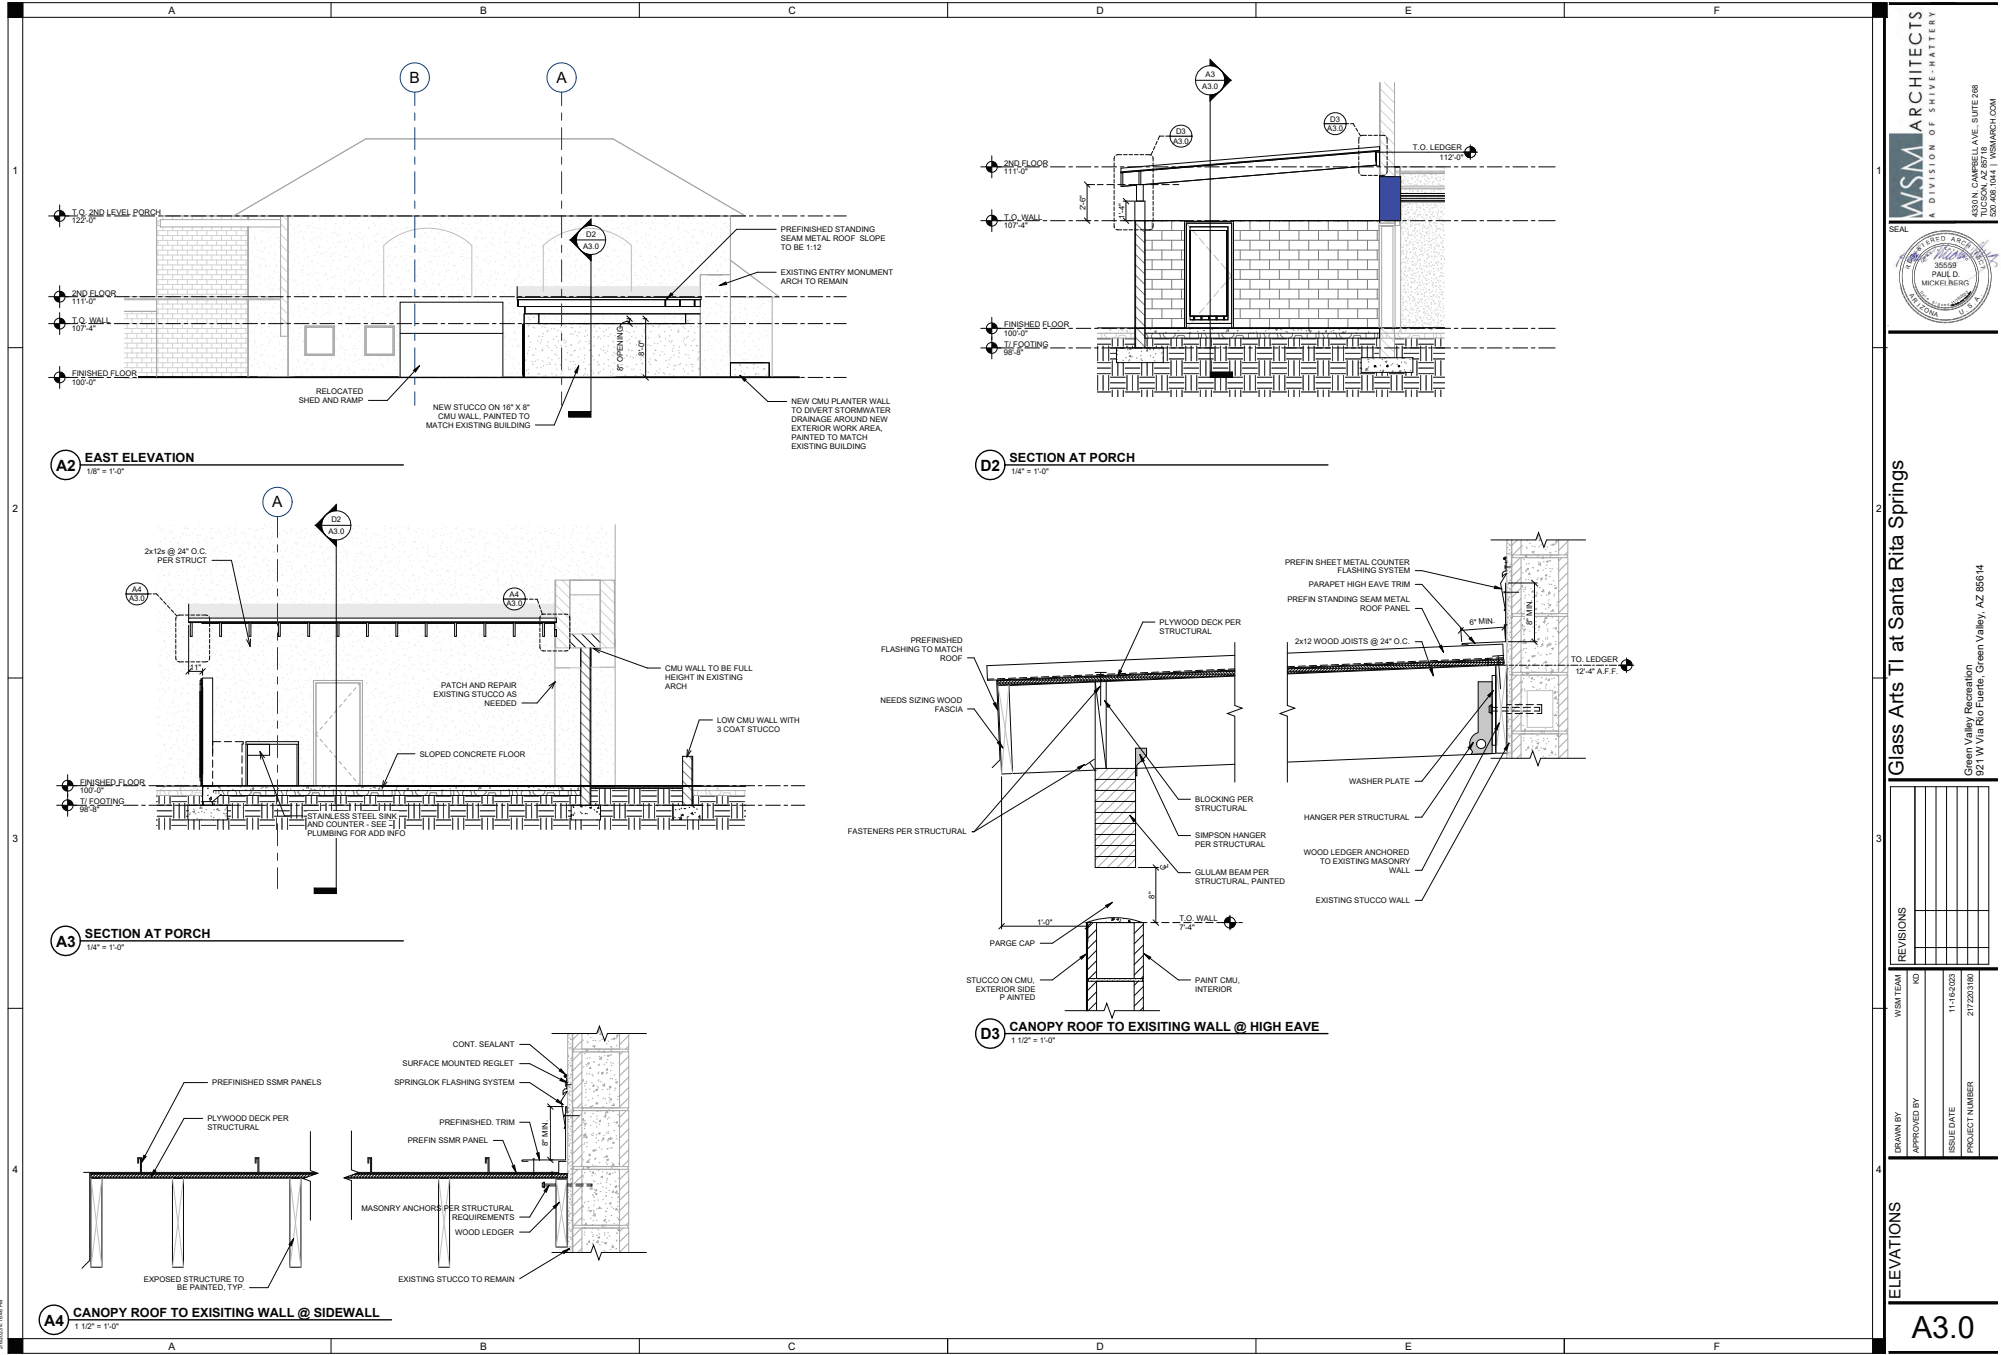NO.	REVISIONS

DRAWN BY	WSMTEAM
APPROVED BY	
ISSUE DATE	11/16/2023
PROJECT NUMBER	217230100

NO.	REVISIONS	DATE
1	T1 (1) SUB	11/16/2023
2	VALUE ENGINEERING	11/16/2023
3		2/17/2024

- KEYNOTES**
- 1 WALL MOUNTED DRY-ERASE MARKER BOARD, O.F.O.I.
 - 2 WALL BASE, 4" HIGH RUBBER BASE BY ROPPE
 - 3 WALL-MOUNTED TV, O.F.O.I. G.C. TO PROVIDE WALL BOX FOR POWER/DATA AND WALL BLOCKING - COORDINATE HEIGHT WITH OWNER
 - 4 WALL MOUNTED COUNTERTOP BRACKET
 - 5 FURNITURE, GLASS ARTISTS CLUB-PURCHASED, CLUB INSTALLED
 - 6 LOCKERS - EXISTING SALVAGED FROM GVR LOCKER ROOM REMODELS - O.F.O.I.



ARCHITECT: W&M ARCHITECTS
 PROJECT: GLASS ARTS T1 AT SANTA RITA SPRINGS
 DATE: 11/16/2023




REVISIONS	
1	TUTS/3/21 VALUE ENGINEERING


W&M TEAM	NO
APPROVED BY	11/16/2023
ISSUE DATE	217230100
PROJECT NUMBER	

KEYNOTES


- 1 WALL MOUNTED DRY-ERASE MARKER BOARD, O.F.O.I.
- 2 WALL BASE, 4" HIGH RUBBER BASE BY ROPPE
- 3 PLASTIC LAMINATE MILLWORK UPPER CABINET, 24" DEEP
- 4 LOCKERS - EXISTING SALVAGED FROM QVR LOCKER ROOM
- 5 REMODELS - O.F.O.I.

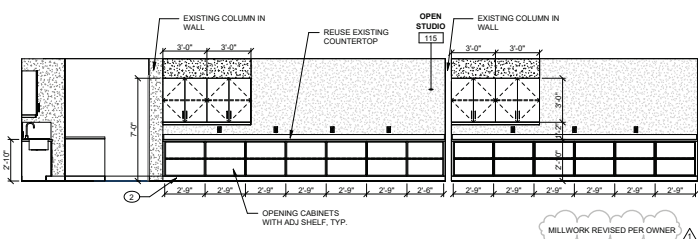


A1 INTERIOR ELEV - RM 115 S
1/4" = 1'-0"

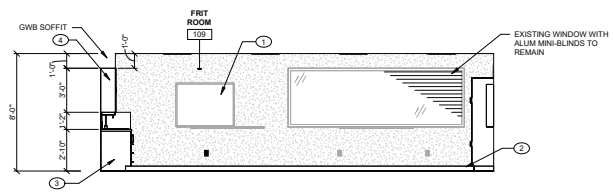


C1 INTERIOR ELEV - RM 109 N
1/4" = 1'-0"

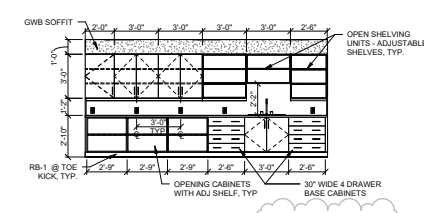


A2 INTERIOR ELEV - RM 109 W
1/4" = 1'-0"

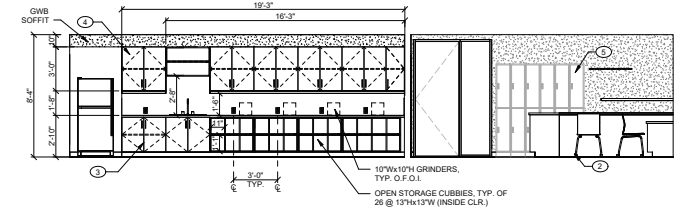


B2 INTERIOR ELEV - RM 103 E
1/4" = 1'-0"

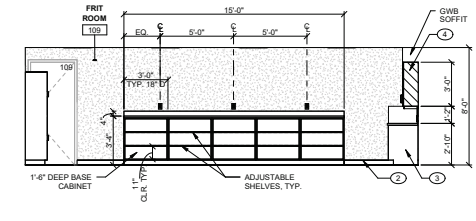


E2 INTERIOR ELEV - RM 109 S
1/4" = 1'-0"

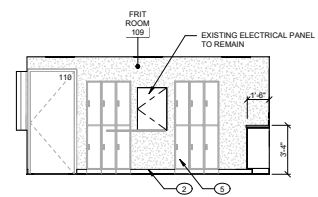


A3 INTERIOR ELEVATION RM. 109 E
1/4" = 1'-0"

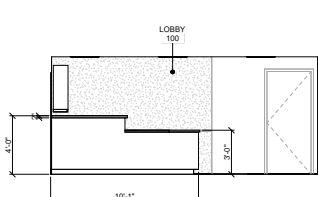


B3 INTERIOR ELEVATION RM. 100 W
1/4" = 1'-0"

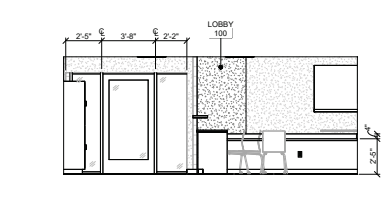


C3 INTERIOR ELEVATION RM. 100 S
1/4" = 1'-0"

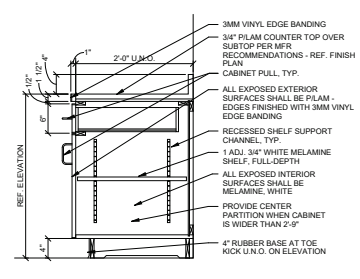


D3 BASE CABINET W/ DRAWER
1" = 1'-0"

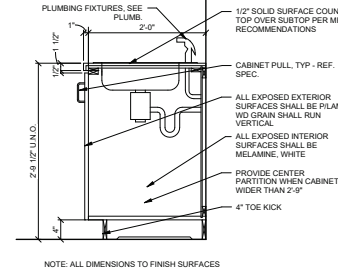


E3 CABINET BASE WITH SINK
1" = 1'-0"

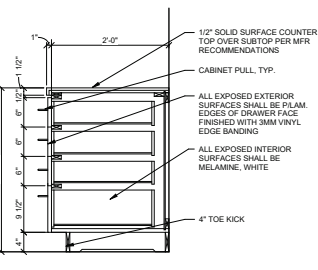


A4 DRAWER BASE CABINET
1" = 1'-0"

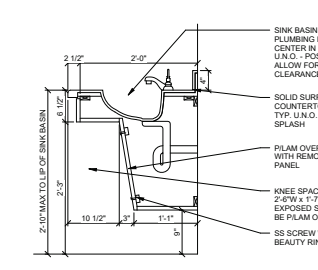


B4 SINK BASE CABINET SECTION
1" = 1'-0"

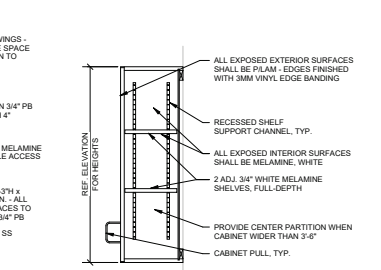

C4 UPPER CABINET
1" = 1'-0"

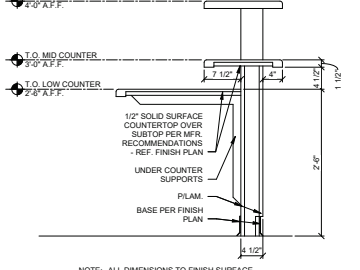


D4 RECEPTION DESK
1" = 1'-0"

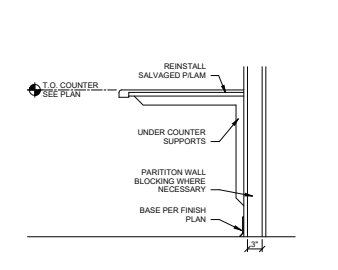

E4 WALL MOUNTED COUNTERTOP
1" = 1'-0"

ANSYS DUCT 01 (2023) 16:00:00 (GMT-07:00) 10/10/2023 10:00:00 AM
 DWG: 217230100_A5.1.dwg
 PLOT: 217230100_A5.1.dwg

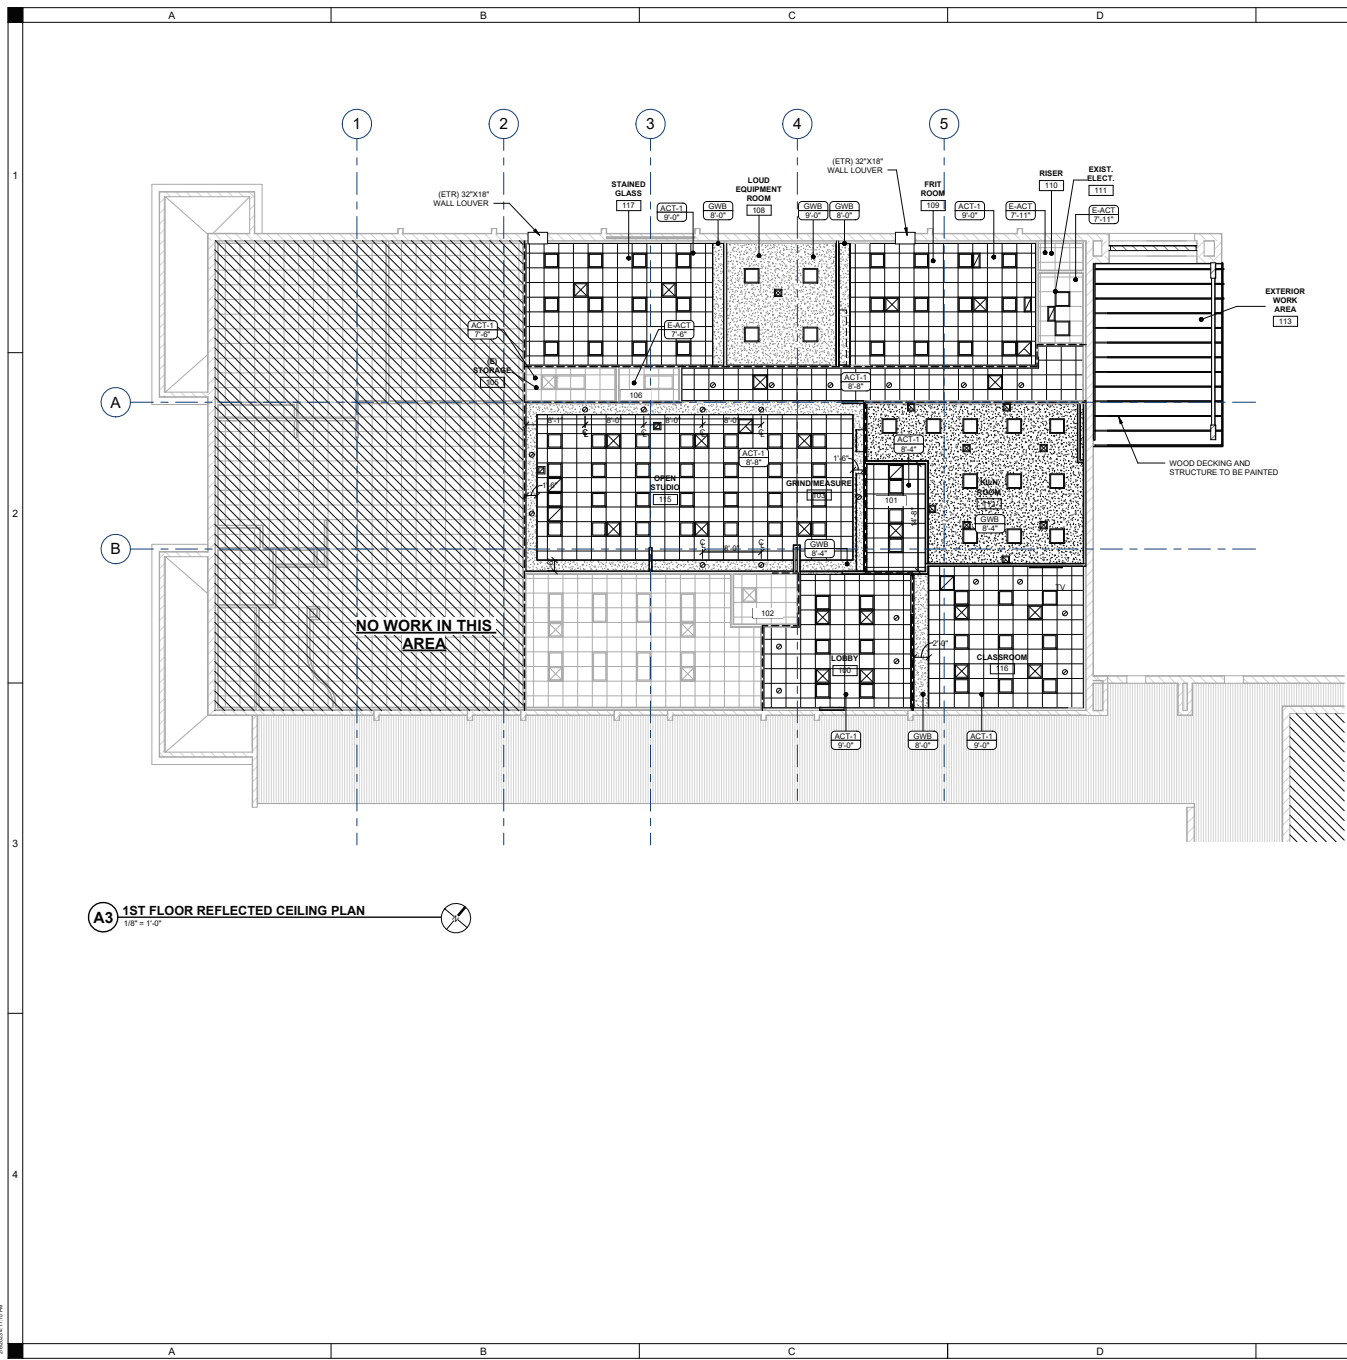

GENERAL RCP NOTES

- A. ALL INTERIOR PARTITION WALLS TO EXTEND FULL HEIGHT TO DECK ABOVE. U.N.O.
- B. ALL EXPOSED BEAMS, DUCTWORK, CONDUIT, PIPING, AND METAL DECK SHALL BE PAINTED.
- C. PROVIDE ACCESS PANELS IN GYPSUM BOARD CEILINGS AT ALL LOCATIONS OF MECHANICAL UNITS, PLUMBING VALVES, AND ELECTRICAL JUNCTION BOXES AND DISCONNECT SWITCHES. REFER TO MECHANICAL AND ELECTRICAL DRAWINGS FOR EXACT LOCATIONS AND QUANTITIES. PAINT TO MATCH CEILING.
- D. IF ANY CONFLICTS WITH SPECIFIED CEILING HEIGHTS ARISE FROM INSTALLED LOCATIONS OF MECHANICAL, PLUMBING, OR ELECTRICAL SYSTEMS OR IF CEILING HEIGHTS ARE NOT SPECIFIED, CONTACT ARCHITECT IMMEDIATELY FOR RESOLUTION. PRIOR TO COMMENCING ANY WORK.
- E. PROVIDE SEISMIC BRACING FOR SUSPENDED CEILING SYSTEM.
- F. ALL WALLS IN ROOMS WITH EXPOSED STRUCTURE SHALL BE FULL HEIGHT AND SEALED TO DECK ABOVE.

RCP LEGEND

- CEILING TYPE
CEILING HEIGHT
- WALL TO EXTEND TO DECK
- WALL TO EXTEND TO CEILING
- EXIT SIGN
- 2' X 2' ACT DROP CEILING
- GWB CEILING
- 2' X 2' RETURN AIR GRILLE
- 2' X 2' SUPPLY AIR GRILLE
- 2' X 2' EXHAUST AIR GRILLE
- RECESSED CAN DOWNLIGHT
- 2' X 2' TROFFER
- 2' X 4' TROFFER
- EXIT SIGN
- WALL PACK LIGHT
- LINEAR SUSPENDED FIXTURE
- 1' X 1' RETURN AIR GRILLE
- 1' X 1' SUPPLY AIR GRILLE
- 1' X 1' EXHAUST AIR GRILLE

A3 1ST FLOOR REFLECTED CEILING PLAN
1/8" = 1'-0"



NO.	REVISIONS

DRAWN BY	WSMTEAM
APPROVED BY	RD
ISSUE DATE	11/16/2023
PROJECT NUMBER	217203100

NO.	DATE	REVISIONS


DRAWN BY	WSMTEAM
APPROVED BY	RD
ISSUE DATE	11-16-2023
PROJECT NUMBER	21723130

DOOR SCHEDULE AND DETAILS

A8.0

4303 N. CAMPBELL AVE., SUITE 208
MESA, AZ 85205
602.498.4344 | WSMARCH.COM

Green Valley Recreation
921 W Via Rio Frio, Green Valley, AZ 85614

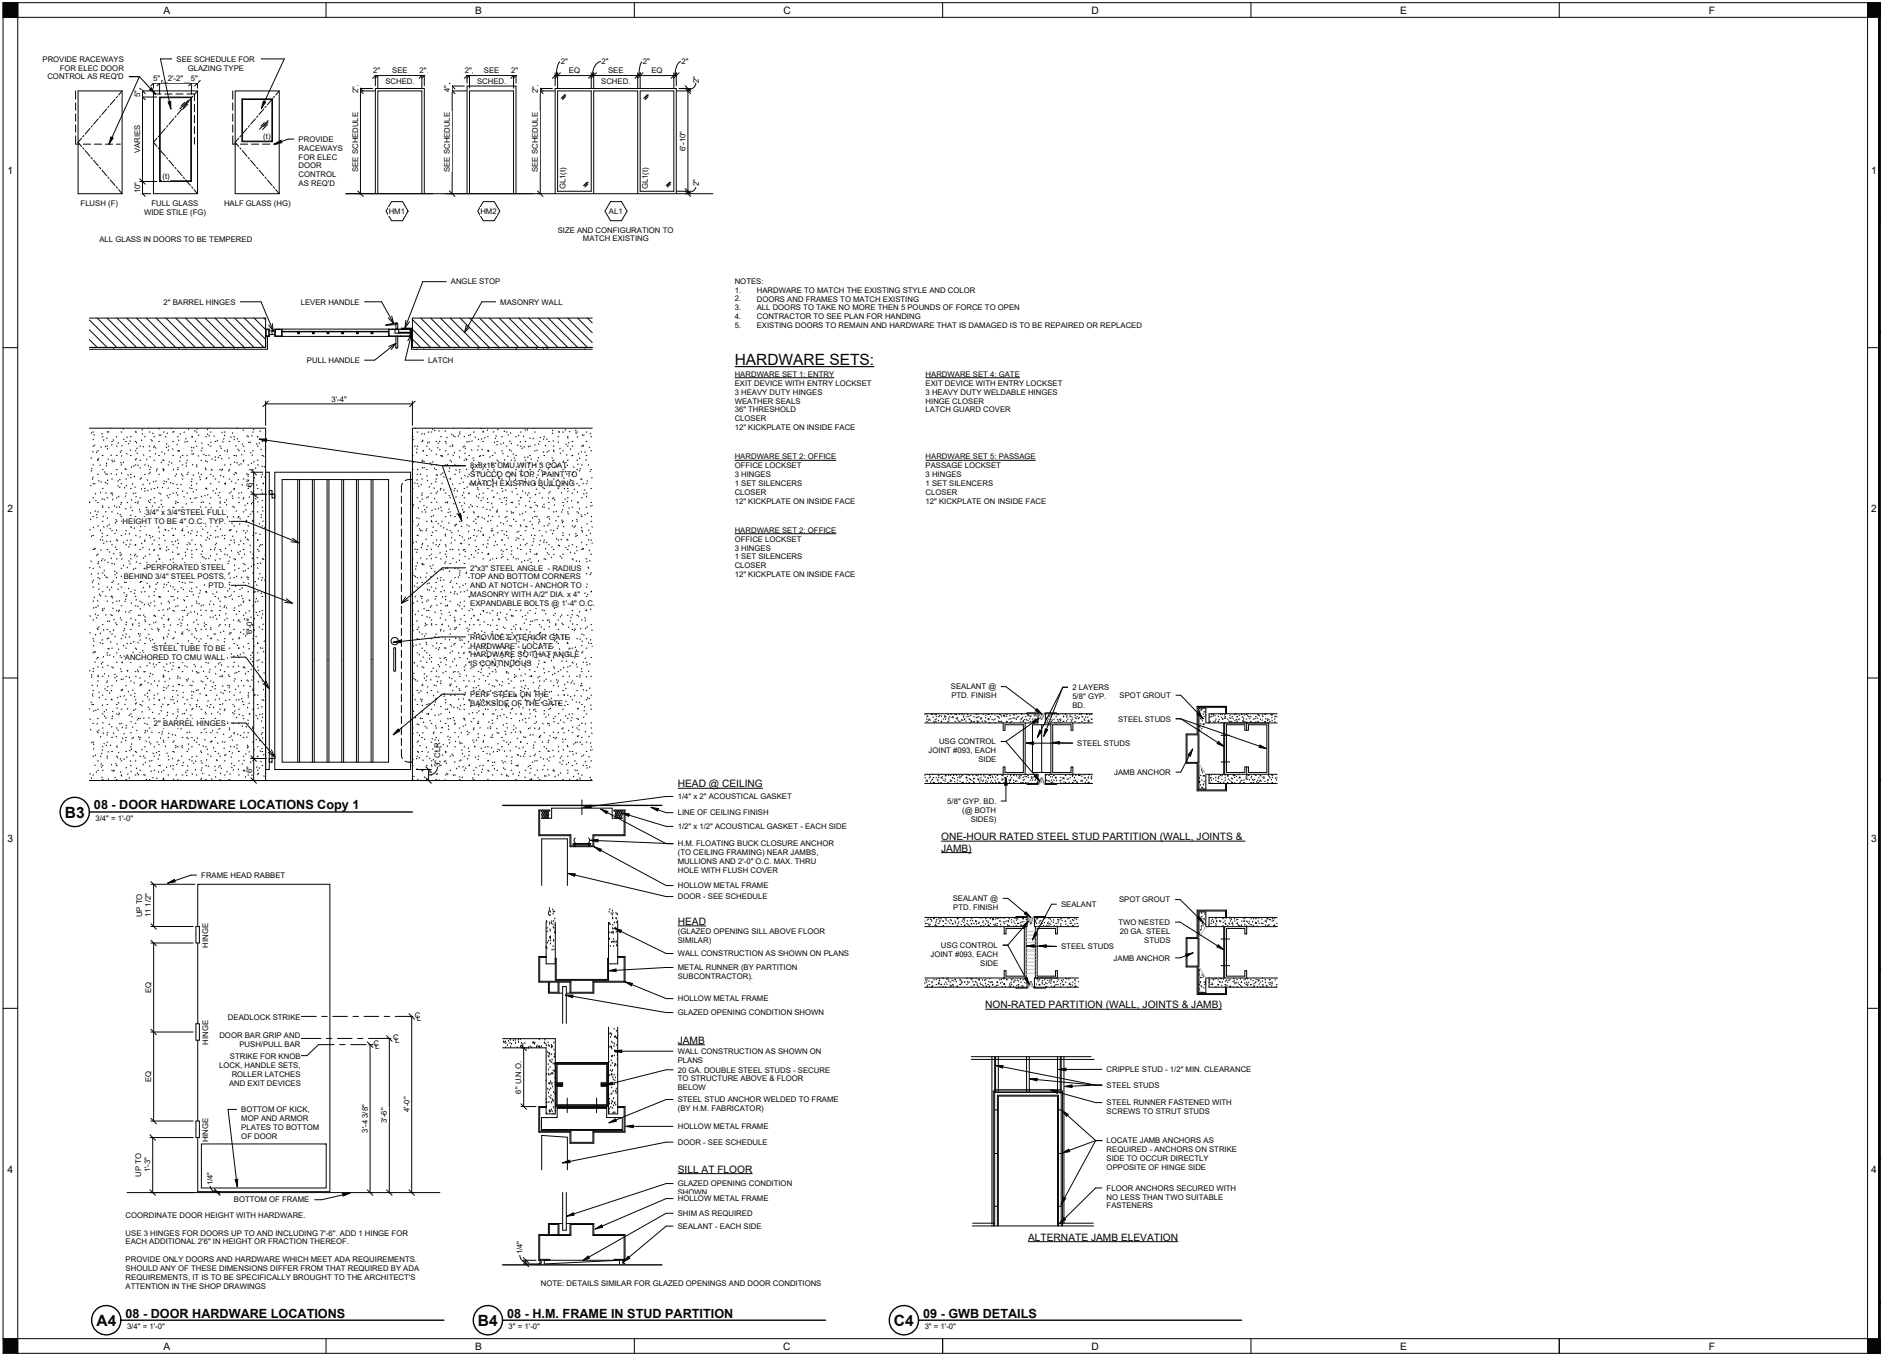


AR0808-0001-01 (2023) (M) (A) (S) (C) (P) (R) (B) (M) (G) (S) (H) (I) (J) (K) (L) (M) (N) (O) (P) (Q) (R) (S) (T) (U) (V) (W) (X) (Y) (Z) (AA) (AB) (AC) (AD) (AE) (AF) (AG) (AH) (AI) (AJ) (AK) (AL) (AM) (AN) (AO) (AP) (AQ) (AR) (AS) (AT) (AU) (AV) (AW) (AX) (AY) (AZ) (BA) (BB) (BC) (BD) (BE) (BF) (BG) (BH) (BI) (BJ) (BK) (BL) (BM) (BN) (BO) (BP) (BQ) (BR) (BS) (BT) (BU) (BV) (BW) (BX) (BY) (BZ) (CA) (CB) (CC) (CD) (CE) (CF) (CG) (CH) (CI) (CJ) (CK) (CL) (CM) (CN) (CO) (CP) (CQ) (CR) (CS) (CT) (CU) (CV) (CW) (CX) (CY) (CZ) (DA) (DB) (DC) (DD) (DE) (DF) (DG) (DH) (DI) (DJ) (DK) (DL) (DM) (DN) (DO) (DP) (DQ) (DR) (DS) (DT) (DU) (DV) (DW) (DX) (DY) (DZ) (EA) (EB) (EC) (ED) (EE) (EF) (EG) (EH) (EI) (EJ) (EK) (EL) (EM) (EN) (EO) (EP) (EQ) (ER) (ES) (ET) (EU) (EV) (EW) (EX) (EY) (EZ) (FA) (FB) (FC) (FD) (FE) (FF) (FG) (FH) (FI) (FJ) (FK) (FL) (FM) (FN) (FO) (FP) (FQ) (FR) (FS) (FT) (FU) (FV) (FW) (FX) (FY) (FZ) (GA) (GB) (GC) (GD) (GE) (GF) (GG) (GH) (GI) (GJ) (GK) (GL) (GM) (GN) (GO) (GP) (GQ) (GR) (GS) (GT) (GU) (GV) (GW) (GX) (GY) (GZ) (HA) (HB) (HC) (HD) (HE) (HF) (HG) (HH) (HI) (HJ) (HK) (HL) (HM) (HN) (HO) (HP) (HQ) (HR) (HS) (HT) (HU) (HV) (HW) (HX) (HY) (HZ) (IA) (IB) (IC) (ID) (IE) (IF) (IG) (IH) (II) (IJ) (IK) (IL) (IM) (IN) (IO) (IP) (IQ) (IR) (IS) (IT) (IU) (IV) (IW) (IX) (IY) (IZ) (JA) (JB) (JC) (JD) (JE) (JF) (JG) (JH) (JI) (JJ) (JK) (JL) (JM) (JN) (JO) (JP) (JQ) (JR) (JS) (JT) (JU) (JV) (JW) (JX) (JY) (JZ) (KA) (KB) (KC) (KD) (KE) (KF) (KG) (KH) (KI) (KJ) (KK) (KL) (KM) (KN) (KO) (KP) (KQ) (KR) (KS) (KT) (KU) (KV) (KW) (KX) (KY) (KZ) (LA) (LB) (LC) (LD) (LE) (LF) (LG) (LH) (LI) (LJ) (LK) (LL) (LM) (LN) (LO) (LP) (LQ) (LR) (LS) (LT) (LU) (LV) (LW) (LX) (LY) (LZ) (MA) (MB) (MC) (MD) (ME) (MF) (MG) (MH) (MI) (MJ) (MK) (ML) (MN) (MO) (MP) (MQ) (MR) (MS) (MT) (MU) (MV) (MW) (MX) (MY) (MZ) (NA) (NB) (NC) (ND) (NE) (NF) (NG) (NH) (NI) (NJ) (NK) (NL) (NM) (NO) (NP) (NQ) (NR) (NS) (NT) (NU) (NV) (NW) (NX) (NY) (NZ) (OA) (OB) (OC) (OD) (OE) (OF) (OG) (OH) (OI) (OJ) (OK) (OL) (OM) (ON) (OO) (OP) (OQ) (OR) (OS) (OT) (OU) (OV) (OW) (OX) (OY) (OZ) (PA) (PB) (PC) (PD) (PE) (PF) (PG) (PH) (PI) (PJ) (PK) (PL) (PM) (PN) (PO) (PP) (PQ) (PR) (PS) (PT) (PU) (PV) (PW) (PX) (PY) (PZ) (QA) (QB) (QC) (QD) (QE) (QF) (QG) (QH) (QI) (QJ) (QK) (QL) (QM) (QN) (QO) (QP) (QQ) (QR) (QS) (QT) (QU) (QV) (QW) (QX) (QY) (QZ) (RA) (RB) (RC) (RD) (RE) (RF) (RG) (RH) (RI) (RJ) (RK) (RL) (RM) (RN) (RO) (RP) (RQ) (RR) (RS) (RT) (RU) (RV) (RW) (RX) (RY) (RZ) (SA) (SB) (SC) (SD) (SE) (SF) (SG) (SH) (SI) (SJ) (SK) (SL) (SM) (SN) (SO) (SP) (SQ) (SR) (SS) (ST) (SU) (SV) (SW) (SX) (SY) (SZ) (TA) (TB) (TC) (TD) (TE) (TF) (TG) (TH) (TI) (TJ) (TK) (TL) (TM) (TN) (TO) (TP) (TQ) (TR) (TS) (TT) (TU) (TV) (TW) (TX) (TY) (TZ) (UA) (UB) (UC) (UD) (UE) (UF) (UG) (UH) (UI) (UJ) (UK) (UL) (UM) (UN) (UO) (UP) (UQ) (UR) (US) (UT) (UU) (UV) (UW) (UX) (UY) (UZ) (VA) (VB) (VC) (VD) (VE) (VF) (VG) (VH) (VI) (VJ) (VK) (VL) (VM) (VN) (VO) (VP) (VQ) (VR) (VS) (VT) (VU) (VV) (VW) (VX) (VY) (VZ) (WA) (WB) (WC) (WD) (WE) (WF) (WG) (WH) (WI) (WJ) (WK) (WL) (WM) (WN) (WO) (WP) (WQ) (WR) (WS) (WT) (WU) (WV) (WW) (WX) (WY) (WZ) (XA) (XB) (XC) (XD) (XE) (XF) (XG) (XH) (XI) (XJ) (XK) (XL) (XM) (XN) (XO) (XP) (XQ) (XR) (XS) (XT) (XU) (XV) (XW) (XX) (XY) (XZ) (YA) (YB) (YC) (YD) (YE) (YF) (YG) (YH) (YI) (YJ) (YK) (YL) (YM) (YN) (YO) (YP) (YQ) (YR) (YS) (YT) (YU) (YV) (YW) (YX) (YZ) (ZA) (ZB) (ZC) (ZD) (ZE) (ZF) (ZG) (ZH) (ZI) (ZJ) (ZK) (ZL) (ZM) (ZN) (ZO) (ZP) (ZQ) (ZR) (ZS) (ZT) (ZU) (ZV) (ZW) (ZX) (ZY) (ZZ)

ARCHITECT: WSM ARCHITECTS
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 TEL: 214.343.1174

	A	B	C	D	E	F
<p>1</p> <p>2</p> <p>3</p> <p>4</p>	<p>A. Concrete, Walls and Ceilings: Poured concrete, precast concrete, unglazed brick, cement board, tilt-up, cast-in-place concrete, and plaster.</p> <p>1. Lateral Systems:</p> <p style="margin-left: 20px;">a. Eg-Shel Finish:</p> <p style="margin-left: 40px;">1) 1st Coat: Sherwin-Williams Loxon Concrete and Masonry Primer Sealer, LX02W50 Series: www.sherwin-williams.com/wfsa.</p> <p style="margin-left: 40px;">2) 2nd and 3rd Coat: Sherwin-Williams ProMar 200 Zero VOC Eg-Shel, 802-8020 Series: www.sherwin-williams.com/wfsa.</p> <p>B. Concrete Ceilings: Poured concrete, precast concrete, cement board, cast-in-place concrete, and plaster.</p> <p>1. Dryfall Waterborne Topcoats:</p> <p style="margin-left: 20px;">a. Flat Finish:</p> <p style="margin-left: 40px;">1) 1st and 2nd Coat: Sherwin-Williams Pro Industrial Waterborne Acrylic Dryfall, B42-181 Series: www.sherwin-williams.com/wfsa.</p> <p>C. Masonry CMU: Concrete, split face, scored, smooth, high density, low density, and fluted.</p> <p>D. Metal: Structural steel columns, joists, trusses, beams, miscellaneous and ornamental iron, structural iron, and ferrous metal.</p> <p>PART 3 EXECUTION</p> <p>3.01 PREPARATION</p> <p>A. Clean surfaces thoroughly and correct defects prior to application.</p> <p>B. Prepare surfaces using the methods recommended by the manufacturer for achieving the best result for the substrate under the project conditions.</p> <p>3.02 APPLICATION</p> <p>A. Apply products in accordance with manufacturer's written instructions.</p> <p>B. Apply coatings at spread rate required to achieve manufacturer's recommended dry film thickness.</p> <p>3.03 PRIMING</p> <p>A. Apply primer to all surfaces unless specifically not required by coating manufacturer. Apply in accordance with coating manufacturer's instructions.</p> <p style="text-align: center;">DIVISION 10 - SPECIALTIES SECTION 10 44 00 FIRE PROTECTION SPECIALTIES</p> <p>PART 1 GENERAL</p> <p>1.01 SUBMITTALS</p> <p>A. Product Data: Provide extinguisher ratings and classifications, color and finish, anchorage details, and installation instructions.</p> <p>PART 2 PRODUCTS</p> <p>2.01 FIRE EXTINGUISHER CABINETS</p> <p>A. Cabinet Construction: Non-fire rated.</p> <p>B. Cabinet Configuration: Semi-recessed type.</p> <p>C. Trim: Flat rolled edge.</p> <p>D. Door: 0.036 inch (0.9 mm) metal thickness, reinforced for flatness and rigidity with nylon catch. Hinge doors for 180 degree opening with two butt hinges.</p> <p>E. Door Glazing: Acrylic plastic, clear, 1/8 inch (3 mm) thick, flat shape and set in resilient channel glazing gasket.</p> <p>F. Cabinet Mounting Hardware: Appropriate to cabinet, with pre-drilled holes for placement of anchors.</p> <p>G. Finish of Cabinet Exterior Trim and Door: Baked enamel, white color.</p> <p>H. Finish of Cabinet Interior: White colored enamel.</p> <p>PART 3 EXECUTION</p> <p>3.01 INSTALLATION</p> <p>A. Install in accordance with manufacturer's instructions.</p> <p>B. Install cabinets plumb and level in wall openings, 48 inches from finished floor to top of extinguisher handle.</p> <p>C. Secure rigidly in place.</p> <p style="text-align: center;">DIVISION 12 - FURNISHINGS SECTION 12 24 00 WINDOW SHADES - MECHOSHADE SYSTEMS</p> <p>PART 1 GENERAL</p> <p>1.01 SUBMITTALS</p> <p>A. Product Data: Provide manufacturer's standard catalog pages and data sheets for each product to be used including materials, finishes, fabrication details, dimensions, profiles, mounting requirements, and accessories.</p> <p>B. Shop Drawings: Include shade schedule indicating size, location and keys to details.</p> <p>C. Verification Samples: Minimum size 6 inches (150 mm) square, representing actual materials, color and pattern.</p> <p>D. Project Record Documents: Record actual locations of control system components and show interconnecting wiring.</p> <p>1.02 WARRANTY</p> <p>A. Provide manufacturer's standard, non-depreciating warranty, for interior shading only, covering the following:</p> <p style="margin-left: 20px;">1. Shade Hardware: 10 years unless otherwise indicated.</p> <p style="margin-left: 20px;">a. Mecho 2s with TransmView, EuroView, EuroView, Soho, Equinox, Madrite, Chelsea, or Classic Blackout shade fabric: 25 years.</p> <p style="margin-left: 20px;">2. Shade Fabric: 10 years unless otherwise indicated.</p> <p>PART 2 PRODUCTS</p> <p>2.01 ROLLER SHADES</p> <p>A. General:</p> <p style="margin-left: 20px;">1. Provide shade system components that are capable of being removed or adjusted without removing mounted shade brackets or cassette support channel.</p> <p style="margin-left: 20px;">2. Provide shade system that operates smoothly when shades are raised or lowered.</p> <p>B. Roller Shades - Typical Basis of Design: MechoShade Systems LLC; Mecho's BRACKET WITH FASCIA</p> <p>2.02 SHADE FABRIC</p> <p>A. Fabric: Non-flammable, color-fast, impervious to heat and moisture, and able to retain its shape under normal operation.</p> <p style="margin-left: 20px;">1. Basis of Design:</p> <p style="margin-left: 40px;">a. Type W11: MechoShades; Soho 1100 Series (1% Open)</p> <p style="margin-left: 40px;">2. Performance Requirements:</p> <p style="margin-left: 60px;">a. Flammability: Pass NFPA 701 large or small scale test.</p> <p style="margin-left: 60px;">b. Fungal Resistance: No growth when tested according to ASTM G21.</p> <p style="margin-left: 60px;">3. Color: to be selected by architect from manufacturer's full range.</p> <p>PART 3 EXECUTION</p> <p>3.01 INSTALLATION</p> <p>A. Install in accordance with manufacturer's instructions and approved shop drawings, using mounting devices as indicated.</p> <p>B. Adjust level, projection, and shade centering from mounting bracket. Verify there is no telescoping of shade fabric. Ensure smooth shade operation.</p>					

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Glass Arts T1 at Santa Rita Springs

Green Valley Recreation
921 W Via Rio Fuerte, Green Valley, AZ 85614

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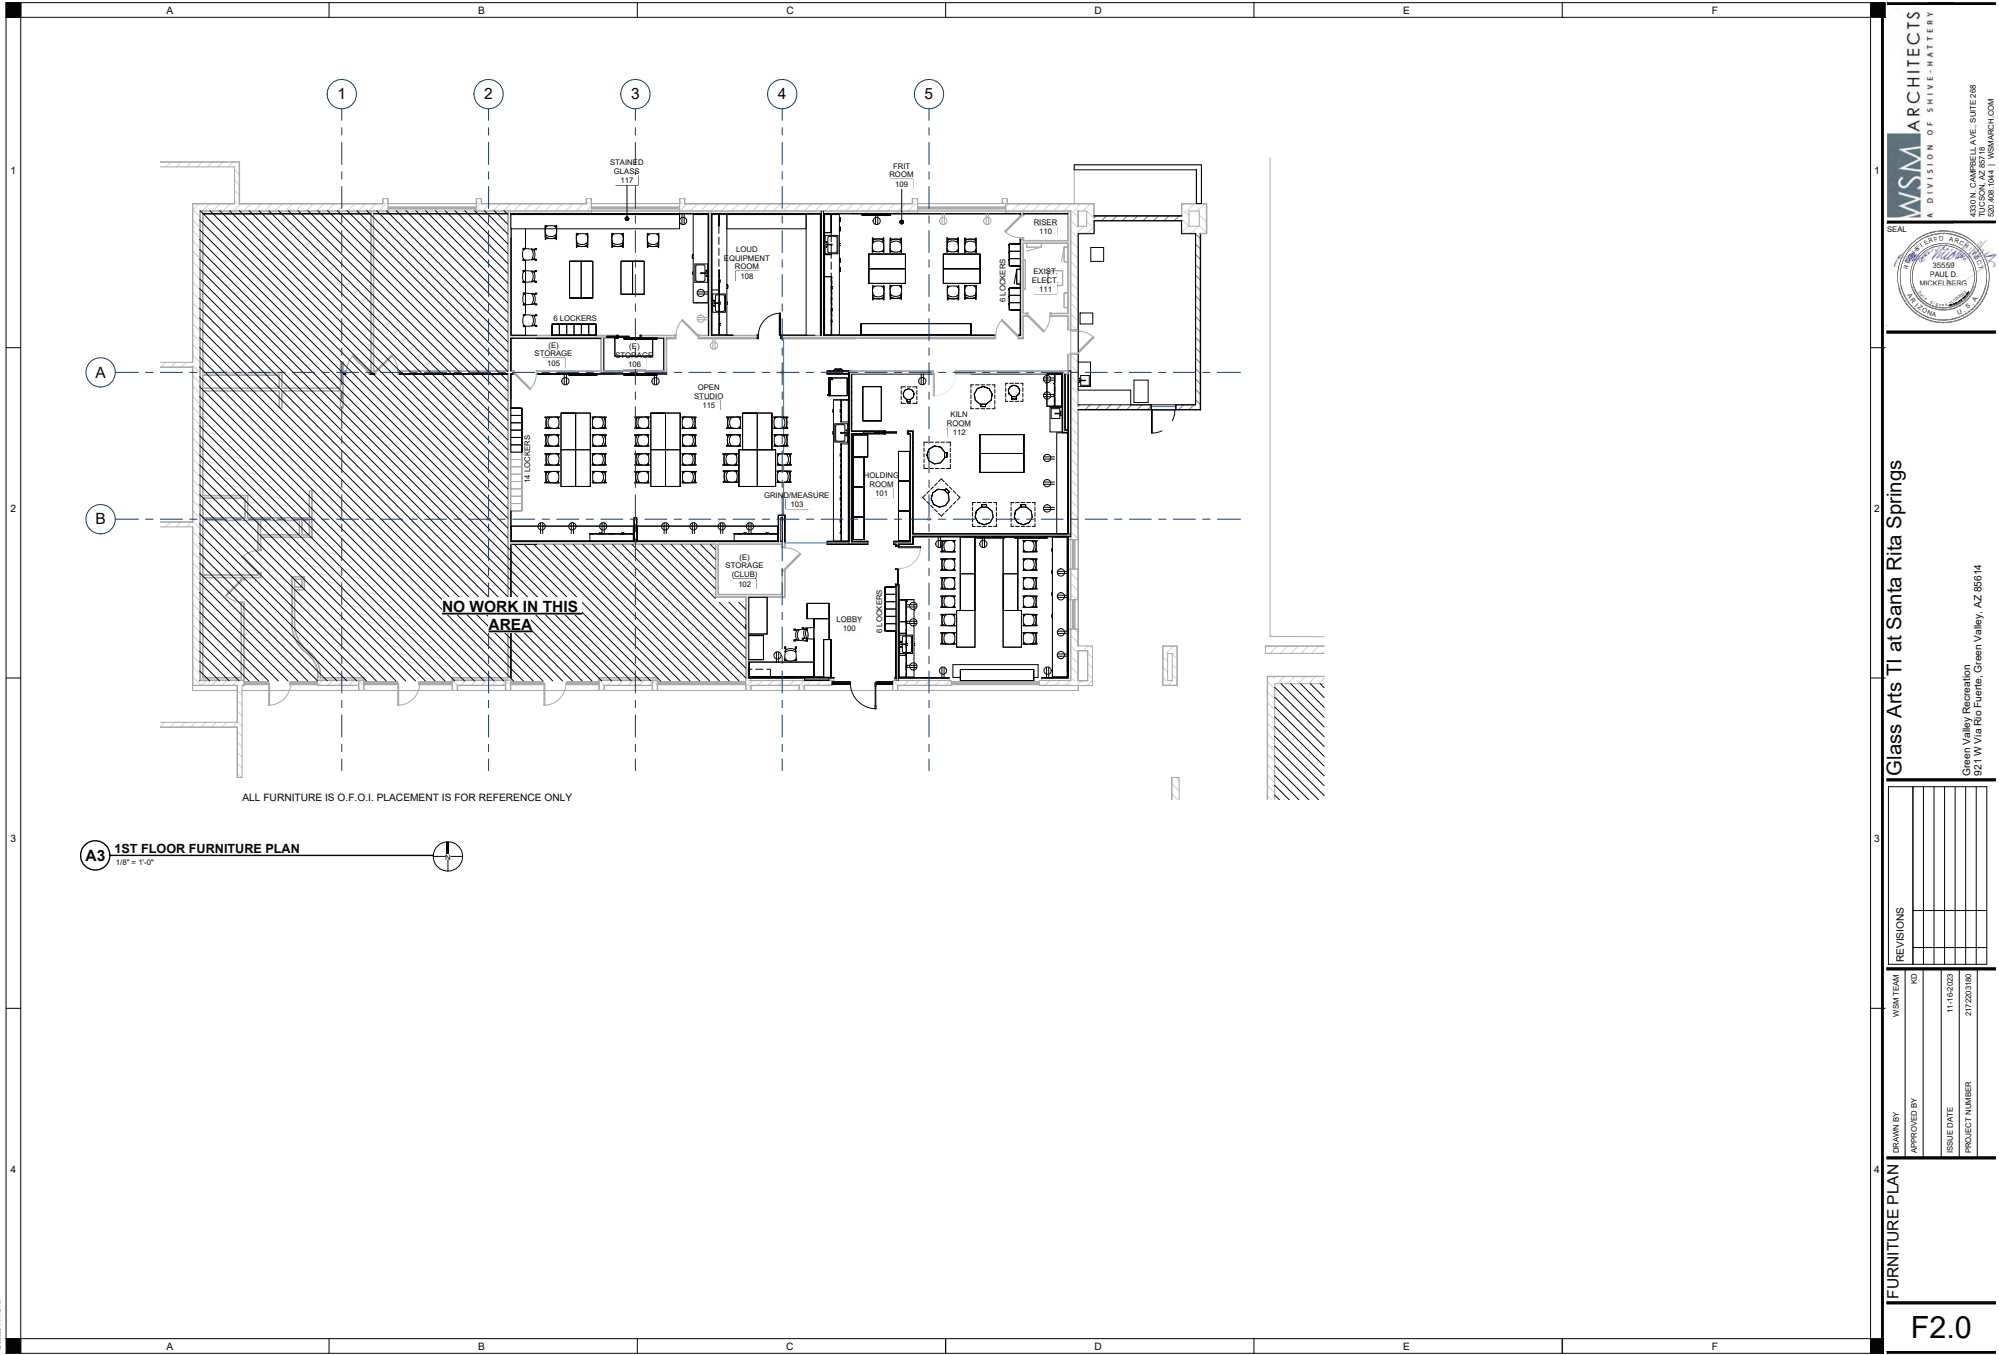
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APPROVED BY					
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PROJECT NUMBER		217230100			

SHEETS

SPECIFICATIONS

A10.3





A3 1ST FLOOR FURNITURE PLAN
1/8" = 1'-0"

ALL FURNITURE IS O.F.O.I. PLACEMENT IS FOR REFERENCE ONLY

NO WORK IN THIS AREA

WSM ARCHITECTS
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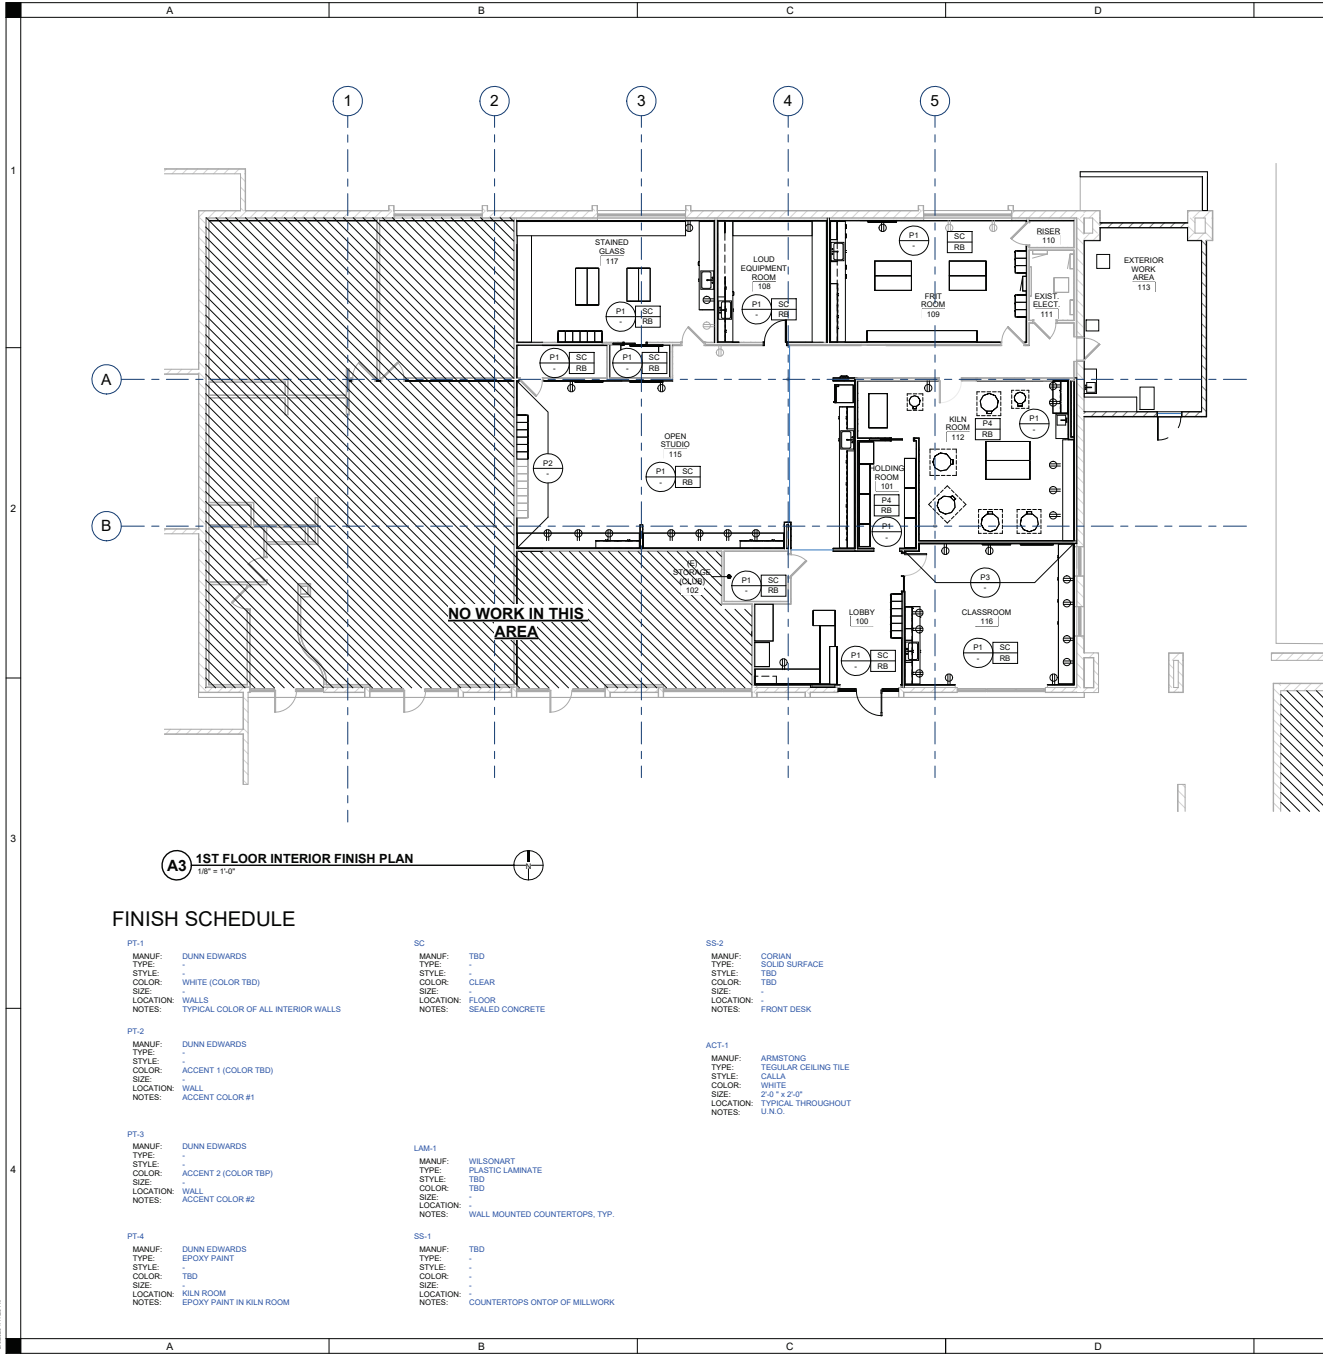
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ISSUE DATE	11/16/2023
PROJECT NUMBER	217230100

FURNITURE PLAN

F2.0

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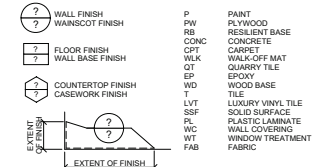


A3 1ST FLOOR INTERIOR FINISH PLAN
1/8" = 1'-0"

FINISH SCHEDULE

<p>PT-1 MANUF: DUNN EDWARDS TYPE: - STYLE: - COLOR: WHITE (COLOR TBD) SIZE: - LOCATION: WALLS NOTES: TYPICAL COLOR OF ALL INTERIOR WALLS</p>	<p>SC MANUF: TBD TYPE: - STYLE: CLEAR COLOR: - SIZE: - LOCATION: FLOOR NOTES: SEALED CONCRETE</p>	<p>SS-2 MANUF: CORIAN TYPE: SOLID SURFACE STYLE: TBD COLOR: TBD SIZE: - LOCATION: - NOTES: FRONT DESK</p>
<p>PT-2 MANUF: DUNN EDWARDS TYPE: - STYLE: ACCENT 1 (COLOR TBD) COLOR: - SIZE: - LOCATION: WALL NOTES: ACCENT COLOR #1</p>	<p>ACT-1 MANUF: ARMSTRONG TYPE: REGULAR CEILING TILE STYLE: CALLA COLOR: WHITE SIZE: 2'-0" x 2'-0" LOCATION: TYPICAL THROUGHOUT NOTES: U.N.O.</p>	
<p>PT-3 MANUF: DUNN EDWARDS TYPE: - STYLE: ACCENT 2 (COLOR TBP) COLOR: - SIZE: - LOCATION: WALL NOTES: ACCENT COLOR #2</p>	<p>LAM-1 MANUF: WILSONART TYPE: PLASTIC LAMINATE STYLE: TBD COLOR: TBD SIZE: - LOCATION: - NOTES: WALL MOUNTED COUNTERTOPS, TYP.</p>	
<p>PT-4 MANUF: DUNN EDWARDS TYPE: EPOXY PAINT STYLE: - COLOR: TBD SIZE: - LOCATION: KILN ROOM NOTES: EPOXY PAINT IN KILN ROOM</p>	<p>SS-1 MANUF: TBD TYPE: - STYLE: - COLOR: - SIZE: - LOCATION: - NOTES: COUNTERTOPS ON TOP OF MILLWORK</p>	

FINISH SYMBOLS



GENERAL FINISH PLAN NOTES

- A. CONTRACTOR SHALL REVIEW ALL SECTIONS OF THIS DOCUMENT AND SHALL BE RESPONSIBLE FOR ITS CONTENTS. CONTRACTOR TO NOTIFY ARCHITECT OF ANY DISCREPANCIES OR OMISSIONS PRIOR TO BID.
- B. FOR ANY ITEM REQUIRING A COLOR OR FINISH SELECTION THAT IS NOT INDICATED, PLEASE CONTACT ARCHITECT IMMEDIATELY.
- C. CHANGES IN FLOOR TYPES AT THE DOOR OPENING SHALL OCCUR AT THE CENTER OF THE DOOR U.N.O.
- D. SUBMIT CONTROL JOINT LOCATION FOR ALL TILE FLOOR AREAS FOR APPROVAL OF ARCHITECT AND OWNER PRIOR TO THE START OF WORK. REVIEW LAYOUT W/ ARCHITECT PRIOR TO INSTALLATION.
- E. CONTRACTOR SHALL CLEAN, PATCH AND REPAIR ALL SURFACES AND SUBSTRATES AS PER FINISH MATERIALS MANUFACTURERS INSTALLATION REQUIREMENTS PRIOR TO INSTALLATION.
- F. PROVIDE ADA-COMPLIANT ALUMINUM FINISH TRANSITION / REDUCER STRIPS THAT OCCUR BETWEEN DISSIMILAR FLOORING MATERIALS AT ALL FLOORING VERTICAL CHANGES IN LEVEL. VERTICAL CHANGES IN LEVEL MAY NOT EXCEED 1/4".
- G. WALL TILE LOCATIONS ARE INDICATED PER PLAN. REFERENCE INTERIOR ELEVATIONS FOR TYPICAL HEIGHTS AND PATTERNS.
- H. SYSTEMS FURNITURE IS D.F.O.I. AND IS INDICATED FOR REFERENCE ONLY.
- I. SEE INTERIOR ELEVATIONS FOR ALL ARCHITECTURAL MILLWORK.
- J. ALL GWB TO RECEIVE LEVEL 5 FINISH SMOOTH, U.N.O., REFERENCE SPEC.
- K. PAINT ALL INTERIOR GWB WALLS COLOR (P-1), U.N.O. SEE FINISH PLANS FOR ACCENT COLOR LOCATIONS.
- L. PAINT ALL GWB CEILING AND SOFFITS (P-1), U.N.O.
- M. ALL MISCELLANEOUS PRIMED METAL TO BE PAINTED. COLOR TO BE SELECTED BY ARCHITECT.
- N. LOCATE RUBBER BASE ONLY AT BASE OF GWB WALLS. WALLS WITH TILE, CONCRETE, MASONRY OR WOOD PANELING DO NOT REQUIRE RUBBER BASE.
- O. PROVIDE IPC CORNER GUARDS AT ALL EXTERIOR CORNERS UP TO 4'-0" A.F.F.
- P. ALIGN GROUT JOINTS FOR FLOOR TILE / WALL TILE / WALL BASE. DO NOT STAGGER JOINTS. PROVIDE RUBBER WALL BASE FOR ALL ROOMS SCHEDULED TO RECEIVE MODULAR CARPET TILE.
- Q. FOR ALL AREAS SCHEDULED TO RECEIVE RESILIENT FLOORING, INCLUDING VCT, PROVIDE VAPOR BARRIER UNDER SLAB, TYP.
- R. RECEPTACLE AND SWITCH COVER FINISH TO BE *STAINLESS STEEL* <WHITE>

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NO.	REVISIONS

DRAWN BY	WSMTEAM
APPROVED BY	
ISSUE DATE	11/16/2023
PROJECT NUMBER	217203100

INTERIOR FINISH PLAN
12.0

GENERAL STRUCTURAL NOTES

(APPLY UNLESS NOTED OTHERWISE)

- ALL WORK SHALL CONFORM TO THE 2018 INTERNATIONAL BUILDING CODE.
- NOTES AND DETAILS ON DRAWINGS SHALL TAKE PRECEDENCE OVER GENERAL STRUCTURAL NOTES AND TYPICAL DETAILS. WHERE NO SPECIFIC DETAILS ARE SHOWN, CONSTRUCTION SHALL CONFORM TO SIMILAR WORK ON THE PROJECT.
- VERIFY ALL DIMENSIONS WITH ARCHITECTURAL DRAWINGS PRIOR TO START OF CONSTRUCTION - RESOLVE ANY DISCREPANCY WITH ARCHITECT. DO NOT SCALE DRAWINGS.
- FOR CLARITY, ALL ROOF, FLOOR, AND WALL OPENINGS MAY NOT BE SHOWN ON STRUCTURAL DRAWINGS. FOR EXACT SIZE, NUMBER, AND LOCATION OF OPENINGS, SEE THE ARCHITECTURAL, MECHANICAL, ELECTRICAL, AND PLUMBING DRAWINGS. FOR FRAMING AT OPENINGS, SEE TYPICAL STRUCTURAL DETAILS. VERIFY ALL SIZES, WEIGHTS, AND LOCATIONS OF MECHANICAL AND ELECTRICAL EQUIPMENT, DUCTS, ETC. WITH MECHANICAL AND ELECTRICAL ENGINEERS THROUGH THE ARCHITECT.
- CONSTRUCTION MATERIALS SHALL BE SPREAD OUT IF PLACED ON FRAMED FLOORS OR ROOF. LOAD SHALL NOT EXCEED THE DESIGN LIVE LOAD PER SQUARE FOOT.
- THE CONTRACTOR SHALL TAKE ALL MEASURES NECESSARY TO PROTECT THE STRUCTURE DURING CONSTRUCTION INCLUDING, BUT NOT LIMITED TO, BRACING, SHORING, ETC. THE CONTRACTOR SHALL BE RESPONSIBLE FOR THE DESIGN AND IMPLEMENTATION OF ALL SCAFFOLDING, BRACING, AND SHORING. OBSERVATION VISITS TO THE SITE BY THE STRUCTURAL ENGINEER SHALL NOT INCLUDE INSPECTION OF THE ABOVE ITEMS. THE STRUCTURAL ENGINEER WILL NOT BE RESPONSIBLE FOR THE CONTRACTOR'S MEANS, METHODS, TECHNIQUES, SEQUENCES OR PROCEDURES OF CONSTRUCTION. NOR WILL THE STRUCTURAL ENGINEER BE RESPONSIBLE FOR CONSTRUCTION SITE SAFETY, OR THE SAFETY PRECAUTIONS AND THE PROGRAMS INCIDENT THERETO.
- THE CONTRACT STRUCTURAL DRAWINGS REPRESENT THE FINISHED STRUCTURE. THEY DO NOT INDICATE THE METHOD OF CONSTRUCTION.
- ALL SLABS AND FOOTINGS SHALL BEAR ON FIRM, UNDISTURBED NATIVE SOIL. ALL SOIL BELOW FOOTINGS AND SLABS SHALL BE COMPACTED TO 95% MINIMUM IN ACCORDANCE TO ASTM D698. DESIGN SOIL BEARING PRESSURE = 1500 PSF. THE STRUCTURAL ENGINEER ACCEPTS NO RESPONSIBILITY FOR EXISTING SOIL CONDITIONS. FOOTING DESIGN IS BASED UPON MINIMUM INTERNATIONAL BUILDING CODE SOIL BEARING VALUES AS REQUIRED BY THE BUILDING CODE DEPARTMENT IN THE ABSENCE OF A SOIL REPORT. IT SHALL BE THE OWNER'S RESPONSIBILITY TO VERIFY THE SOIL BEARING PRESSURE AND TO DETERMINE WHETHER UNSUITABLE SOIL CONDITIONS (I.E. EXPANSIVE OR COLLAPSIBLE SOILS, LOOSE FILLS, ETC.) EXIST.
- LAP SPLICES FOR REINFORCING IN CONCRETE SHALL BE 30 BAR DIAMETERS MINIMUM.
- LAP SPLICES FOR REINFORCING IN CMU SHALL BE 48 BAR DIAMETERS FOR GRADE 60 REINFORCING U.N.O.
- PROVIDE BENT CORNER BARS TO MATCH AND LAP HORIZONTAL REINFORCING AT CORNERS AND INTERSECTIONS IN CONCRETE FOOTINGS AND WALLS AND MASONRY WALL BOND BEAMS.

- CMU WALLS SHALL BE REINFORCED WITH #5 VERTICAL REINFORCING AT 32" O.C. MAXIMUM, AND AT ALL CORNERS, INTERSECTIONS, WALL ENDS, BEAM BEARINGS, JAMBS, AND EACH SIDE OF CONTROL JOINTS. PROVIDE #9 GAGE WIRE HORIZONTAL JOINT REINFORCING AT 16" O.C.
- ALL NAIL SPACING NOT NOTED SHALL BE ACCORDING TO TABLE 2304.9.1 OF THE INTERNATIONAL BUILDING CODE. SIZE AND NUMBER OF NAILS IN JOIST HANGERS AND MISCELLANEOUS FRAMING ANCHORS SHALL BE ACCORDING TO THE MANUFACTURER'S LATEST CATALOG.
- DESIGN LOADS:
ROOF LIVE LOAD = 20 PSF (REDUCIBLE)
ROOF DEAD LOAD = 15 PSF
ROOF UPLIFT WIND LOAD = 15 PSF (NET)

WIND: BASIC WIND SPEED = 105 MPH, EXPOSURE "C", I = 1.0
SEISMIC: DESIGN CATEGORY B
- MATERIALS OF CONSTRUCTION:

CONCRETE - ASTM C94, Fc = 3000 PSI AT 28 DAYS

REINFORCING - ASTM A615 GRADE 60

CMU - ASTM C90 WITH A NET COMPRESSIVE STRENGTH OF 1500 PSI. Fm = 1500 PSI

GROUT - ASTM C476, 2000 PSI AT 28 DAYS

MORTAR - ASTM C270, TYPE S, PORTLAND CEMENT, 2000 PSI AT 28 DAYS

EPOXY BOLTS IN CMU MASONRY OR CONCRETE - THREADED ROD INSTALLED WITH THE "SET-XP" ADHESIVE SYSTEM BY SIMPSON STRONG-TIE

FRAMING LUMBER - W/WPA OR WCLB STAMPED, 19% MAXIMUM MOISTURE CONTENT, DOUGLAR-FIR LARCH OF THE FOLLOWING GRADES:
TYPICAL U.N.O. - #2
6X POSTS AND BEAMS - #1

GLULAMS - DOUGLAS-FIR LARCH 24F-V8 COMBINATION WITH Fb = 2400 PSI, Fv = 190 PSI, Fc (PERPENDICULAR) = 650 PSI, AND E = 1,800,000 PSI MINIMUM.

PLYWOOD - APA STAMPED WITH AN EXTERIOR OR EXPOSURE 1 DURABILITY CLASSIFICATION NAILED WITH COMMON NAILS. APA RATED SHEATHING (I.E. WAFERBOARD AND ORIENTED STRAND BOARD) CONFORMING TO NER-108 AND WITH THE EQUIVALENT EXPOSURE DURABILITY CLASSIFICATION. THICKNESS AND SPAN INDEX RATIO MAY BE SUBSTITUTED FOR PLYWOOD IF APPROVED IN WRITING BY THE ARCHITECT.
LAY-UP PLYWOOD WITH LONG DIMENSION PERPENDICULAR TO SUPPORTS AND STAGGER JOINTS. BLOCK ALL UNSUPPORTED EDGES AT WALLS.

USE THICKNESS SPAN INDEX EDGE NAILING INTERMEDIATE NAILING
ROOF 1/2" 32/16 8d AT 6" O.C. 8d AT 12" O.C.
- SPECIAL INSPECTIONS:
THE PROJECT IS OF A MINOR NATURE. SPECIAL INSPECTIONS ARE THEREFORE EXEMPTED.

LEDGER (L) SCHEDULE			843
MARK	TYPE/SIZE	CONNECTION	
L1	WOOD/3x12 EPOXIED THREADED RODS AT 24" O.C.	3/4" x 5 1/4" EMBED	
L2	WOOD/2x6 EPOXIED THREADED RODS AT 48" O.C.	3/4" x 5 1/4" EMBED	

WOOD:
1. ALL LEDGERS SHALL HAVE MINIMUM OF 2 ANCHOR BOLTS PER LEDGER PIECE.
2. ANCHOR BOLTS SHALL BE LOCATED NOT LESS THAN 6" NOR MORE THAN 12" FROM END OF LEDGER PIECE OR AT LEDGER SPLICE.


NOTE: PLACE EPOXIED RODS IN GROUTED CELLS IF POSSIBLE. IF NOT POSSIBLE, ANCHOR BOLTS SHALL BE SPACED AT 16" O.C. AND PROVIDE CARBON FIBER SCREENS FOR HOLLOW CELLED EPOXY PER MANUFACTURER.

LINTEL (LT) SCHEDULE				844
MARK	TYPE	LINTEL SIZE	REMARKS	
L1	CMU	H=8", (2) #4 BOTTOM REINFORCING	---	


- NOTES:
1. SCHEDULES APPLY U.N.O. SEE TYPICAL DETAILS FOR ADDITIONAL INFORMATION.



DRAWN:	BSL
APPROVED:	EMG
ISSUED FOR:	###
DATE:	1/22/2022
PROJECT NO:	217203189
FIELD BOOK:	###
CLIENT NO:	###

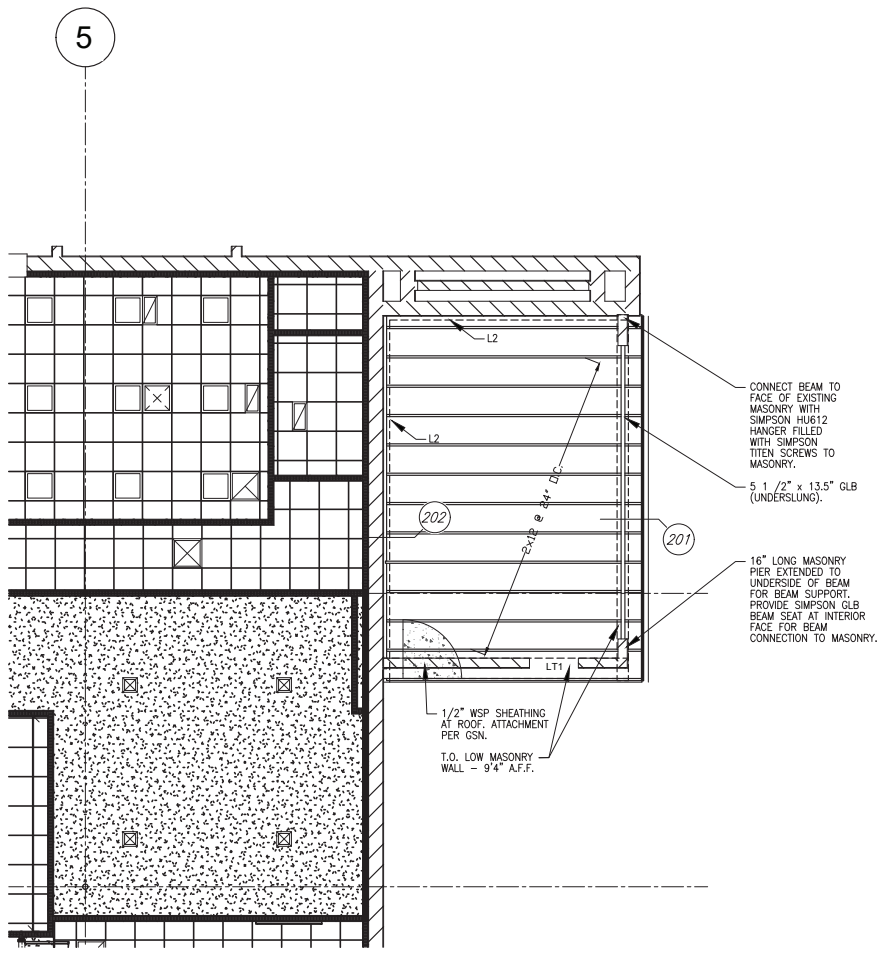






2 PARTIAL ROOF FRAMING PLAN
1/4" = 1'-0"

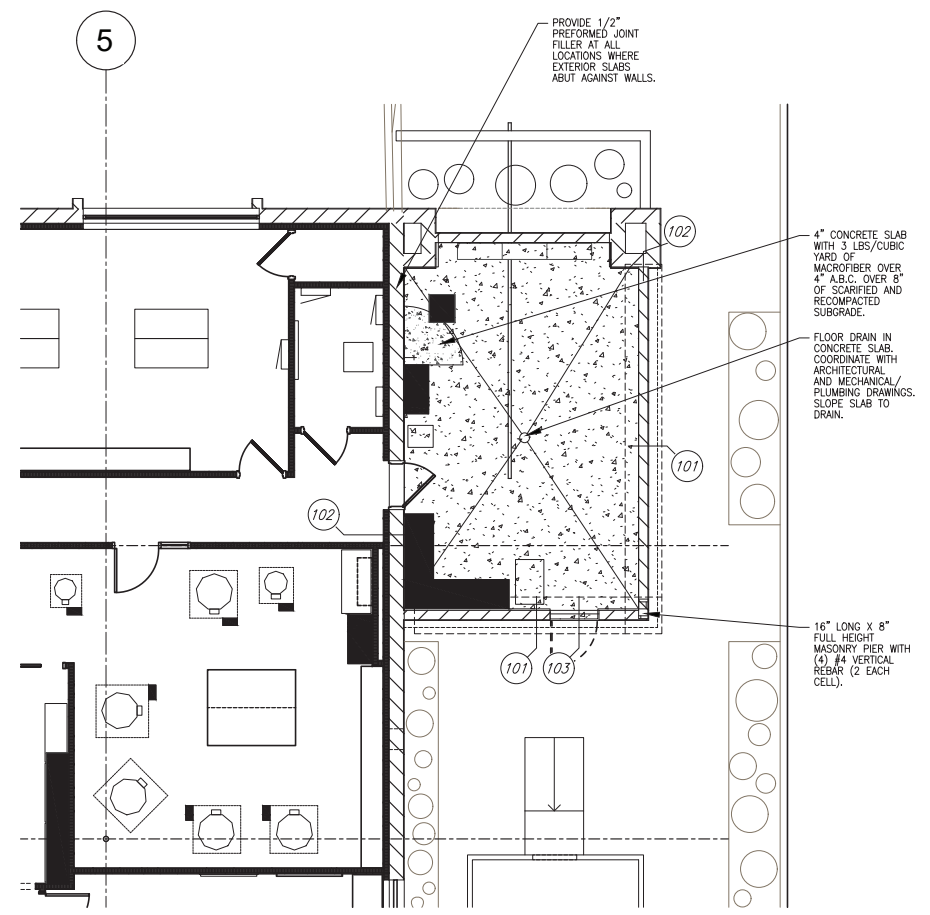

1 PARTIAL FOUNDATION PLAN
1/4" = 1'-0"

DRAWN:	BS
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ISSUED FOR:	MMH
DATE:	1/22/2022
PROJECT NO.:	217203180
FIELD BOOK:	
CLIENT NO.:	MMH


UNLESS THIS DRAWING IS SIGNED AND SEALED BY A LICENSED STRUCTURAL ENGINEER, IT IS A PRELIMINARY DESIGN AND SHALL NOT BE USED FOR CONSTRUCTION.

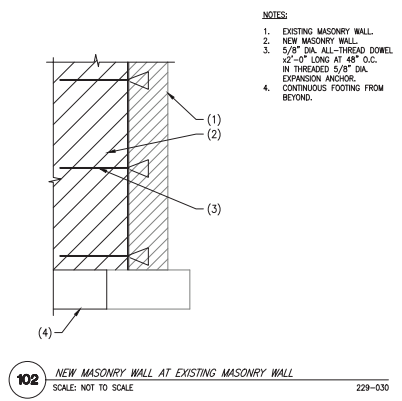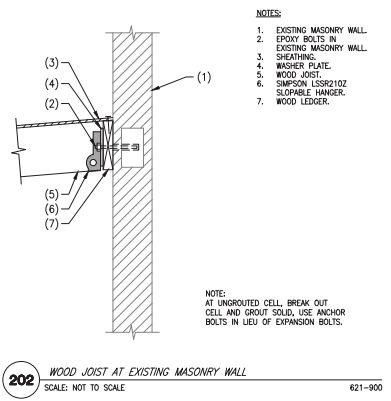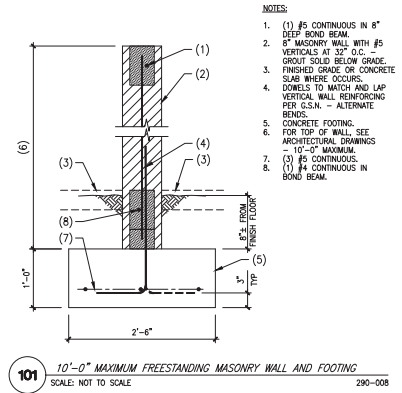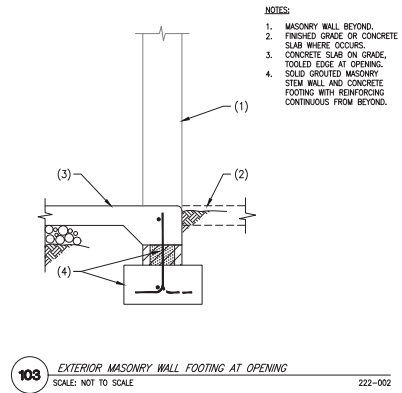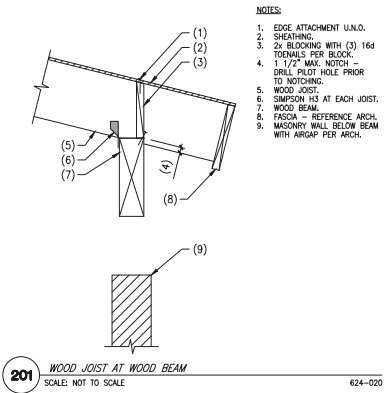

DRAWN:	BS
APPROVED:	EMG
ISSUED FOR:	MMH
DATE:	11/22/2022
PROJECT NO:	217203189
FIELD BOOK:	
CLIENT NO:	MMH



AD	PHM	11/06/22	217203100
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APPROVED BY			FIELD BOOK

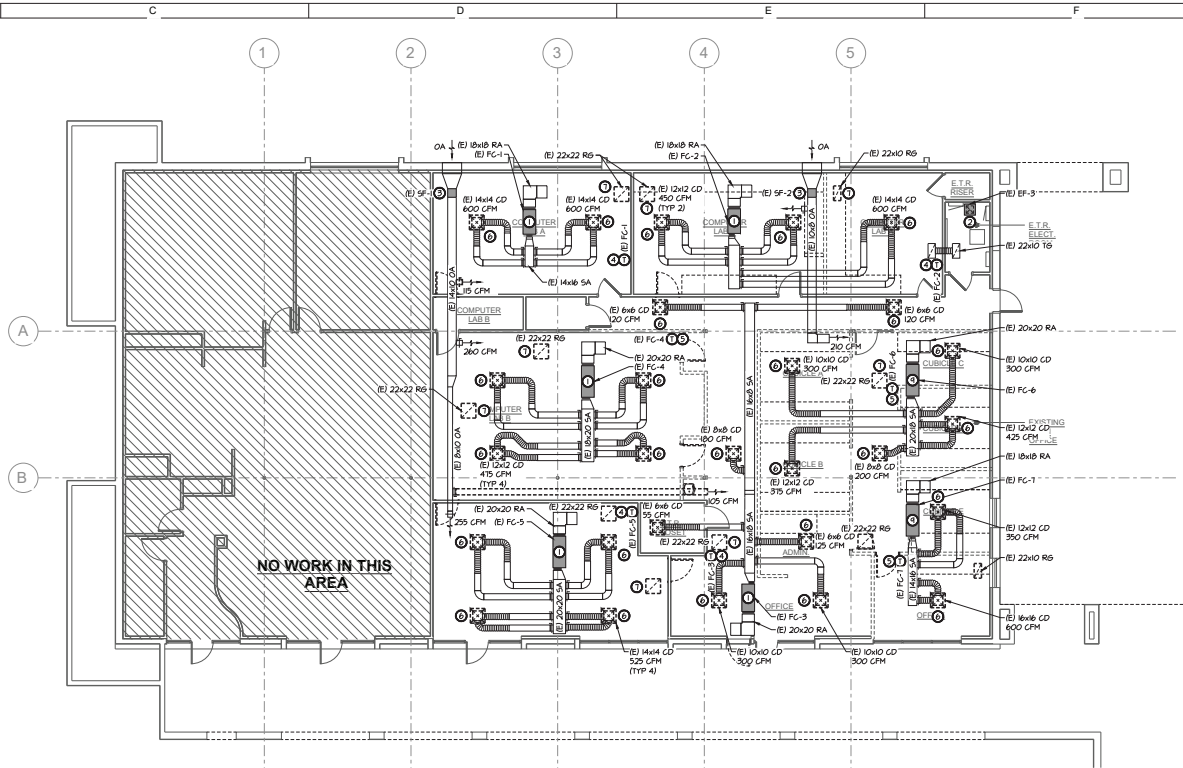

1 MECHANICAL DEMO PLAN - 1ST LEVEL
1/8" = 1'-0"

MECHANICAL DEMOLITION NOTES

- COORDINATE DEMOLITION OF ALL OVERHEAD HVAC ITEMS WITH OTHER TRADES.
- ALL AIR CONDITIONING UNITS SHALL REMAIN UNDO.
- ALL DUCTWORK SHALL REMAIN UNDO.
- ALL AIR DEVICES SHALL REMAIN UNDO.
- ALL EXHAUST FANS SHALL REMAIN UNDO.
- COORDINATE DEMOLITION SCHEDULE AND HOURS OF WORK WITH THE OWNER AND/OR ARCHITECT.
- CONTRACTOR SHALL MAINTAIN PREMISES IN CLEAN CONDITION AT END OF EACH DAY AND THOROUGHLY CLEAN-UP AT END OF CONSTRUCTION.
- COORDINATE PROPER DISPOSAL OF ALL DEMOLITION ITEMS WITH OWNER AND/OR ARCHITECT.
- THE CONTRACTOR SHALL FIELD VERIFY ALL EXISTING CONDITIONS PRIOR TO STARTING WORK.

- KEYNOTES:**
- (E) FC TO REMAIN AS IS.
 - (E) EF TO REMAIN AS IS.
 - (E) SF TO REMAIN AS IS.
 - (E) TSTAT TO REMAIN AS IS.
 - RELOCATE (E) TSTAT, EXTEND CONTROL WIRING AS REQ'D.
 - RELOCATE (E) CD, EXTEND FLEX AS REQ'D.
 - RELOCATE (E) RA.
 - PATCH (E) HAND OA AS REQUIRED.
 - RELOCATE (E) FC, EXTEND DUCT AS REQ'D.






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			PROJECT NUMBER
			FIELD BOOK

MECHANICAL LEGEND		
SYMBOL	ABBREV.	ITEM
		FLEX CONNECTION
	SA	SUPPLY AIR DUCT
	RA	RETURN AIR DUCT
	EA	EXHAUST AIR DUCT
	RG	RETURN AIR GRILLE - KRIEGER MODEL EGC-5 PROVIDE LAY-IN CEILING FRAME. COORDINATE FINISH WITH ARCHITECT.
	RG	RETURN AIR GRILLE - KRIEGER MODEL EGC-5 PROVIDE SURFACE MOUNT FRAME. COORDINATE FINISH WITH ARCHITECT.
	CD	SUPPLY AIR CEILING DIFFUSER - KRIEGER MODEL SH PROVIDE 24x24 PANEL, LAY-IN CEILING FRAME. COORDINATE FINISH WITH ARCHITECT.
	CD	SUPPLY AIR CEILING DIFFUSER - KRIEGER MODEL SH PROVIDE SURFACE MOUNT FRAME. COORDINATE FINISH WITH ARCHITECT.
	EG	EXHAUST GRILLE - KRIEGER MODEL EGC-5 PROVIDE ALUMINUM OBD & SURFACE MOUNT FRAME. COORDINATE FINISH WITH ARCHITECT.
	SR	SUPPLY REGISTER - KRIEGER MODEL 800x400 STANDARD FRAME AND OBD. COORDINATE FINISH WITH ARCHITECT.
	HL	EXTENDED ALUMINUM LOUVER - POTLUFF MODEL EGV-545 WITH INSET SCREEN. COORDINATE FINISH WITH ARCHITECT.
	BD	MANUAL BALANCE DAMPER (BUTTERFLY) FLEX DUCTWORK
	T	THERMOSTAT
	TC	INTERMATIC MODEL 5101, 1-DAY HEAVY DUTY PROGRAMMABLE THER OR EQUAL
	P.O.C.	POINT OF CONNECTION
	DTR	DUCT THRU ROOF
	DTW	DUCT THRU WALL
	SA	SUPPLY AIR
	RA	RETURN AIR
	EA	EXHAUST AIR
	TA	TRANSFER AIR
	OA	OUTSIDE AIR
	EX	EXISTING
	F	FLEX OR ROUND DUCTWORK
	DN	DOWN
	CLG	CEILING
	TV	TURNING VANES
	ABV	ABOVE
	OH	OVERHEAD
	BLW	BELOW
	AFF	ABOVE FINISHED FLOOR
	C.D.	CONDENSATE DRAIN CLEAN OUT
	OBD	OPPOSED BLADE DAMPER
	UNO.	UNLESS NOTED OTHERWISE

NOTE: SOME OF THE ITEMS MAY NOT APPLY TO THIS PROJECT.

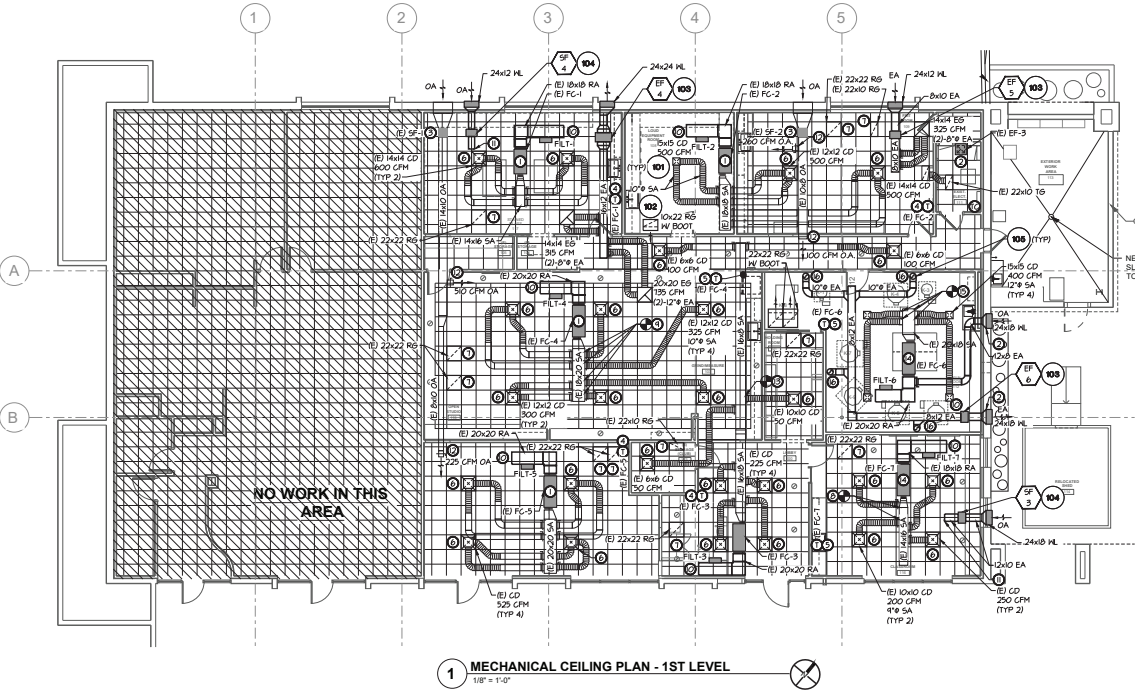

HEPA FILTRATION UNIT SCHEDULE										
MARK	SERVES	MFR AND MODEL	TYPE	CFM	ESP IN IN/S	MOTOR DATA			HEIGHT	REMARKS
						SPEED	HATTS	ELECTRIC		
FILT-1	(E) FC-1	FANTECH DM-300CP	INLINE	240	0.4	1	150	120M&O	30	1, 2, 3
FILT-2	(E) FC-2	FANTECH DM-300CP	INLINE	240	0.4	1	150	120M&O	30	1, 2, 3
FILT-3	(E) FC-3	FANTECH DM-300CP	INLINE	240	0.4	1	150	120M&O	30	1, 2, 3
FILT-4	(E) FC-4	FANTECH DM-300CP	INLINE	240	0.4	1	150	120M&O	30	1, 2, 3
FILT-5	(E) FC-5	FANTECH DM-300CP	INLINE	240	0.4	1	150	120M&O	30	1, 2, 3
FILT-6	(E) FC-6	FANTECH DM-300CP	INLINE	240	0.4	1	150	120M&O	30	1, 2, 3
FILT-7	(E) FC-7	FANTECH DM-300CP	INLINE	240	0.4	1	150	120M&O	30	1, 2, 3

1. INTERLOCK UNIT WITH FC SUPPLY FAN SO THAT THEY OPERATE WHEN THE FC SUPPLY FAN OPERATES.

BUILDING AIR BALANCE SCHEDULE				
MARK	OUTSIDE AIR CFM	EXHAUST AIR CFM	NET AIR	
(E) SF-1	135	-	135	
(E) SF-2	360	-	360	
SF-3	300	-	300	
SF-4	300	-	300	
(E) FC-6	400	-	400	
(E) EF-3	-	-185	-185	
EF-4	-	-1050	-1050	
EF-5	-	-325	-325	
EF-6	-	-400	-400	
NET TOTAL [CFM]			125	

OUTSIDE AIR VENTILATION SCHEDULE PER-IMC-2018 TABLE 403.3											
ROOM NAME & NUMBER	AREA FT ²	PEOPLE PER 1000 FT ²	TOTAL PEOPLE	O.A. PER PERSON	CFM/1000 FT ²	O.A. REQ	EA REQ	CORRECTED O.A. TOTAL	UNIT SERVING	REMARKS	
101 LOBBY	321	10	33	5	0.06	36	--				
103 STORAGE CORRIDOR	51	NA	NA	NA	0.12	1	--	MAX. ZP + 0.39 VOU / EV + 8	(E) FC-3	100 CFM OF O.A. PROVIDED BY (E) SF-2	
101 HOLDING ROOM	116	NA	NA	NA	0.12	14	--				
106 CLASSROOM	451	35	153	10	0.12	205	--	E2: 0.8 VOU-253	(E) FC-1	275 CFM OF O.A. PROVIDED BY SF-3	
MEETING	568	50	285	5	0.06	176	--	E2: 0.8 VOU-216	(E) FC-5	225 CFM OF O.A. PROVIDED BY (E) SF-1	
112 KILN ROOM	511	NA	NA	NA	0.12	62	--	E2: 0.8 VOU-18	(E) FC-6	400 CFM OF O.A. PROVIDED BY SF-5	
103 GROUND MEASURE	344	20	69	10	0.18	131	241	MAX. ZP + 0.28 VOU / EV + 503	(E) FC-4	910 CFM OF O.A. PROVIDED BY (E) SF-1	
115 OPEN STUDIO	106	20	41	10	0.18	268	494				
105 STORAGE	54	NA	NA	NA	0.12	6	--				
104 STAINED GLASS	444	20	89	10	0.18	161	311	MAX. ZP + 0.18 VOU / EV + 182	(E) FC-1	325 CFM OF O.A. PROVIDED BY SF-4	
106 STORAGE	36	NA	NA	NA	0.12	4	--				
108 EQUIPMENT ROOM	246	NA	NA	NA	0.12	30	--	MAX. ZP + 0.21 VOU / EV + 221	(E) FC-2	260 CFM OF O.A. PROVIDED BY (E) SF-2	
104 FRONT ROOM	442	20	88	10	0.18	165	308				
111 ELEC. ROOM	57	NA	NA	NA	0.12	7	--				

BALANCE O.A. TO CFM AMOUNT SHOWN.

- GENERAL NOTES:**
A. CONTRACTOR TO CLEAN AND REUSE EXISTING AIR DEVICES.
- KEYNOTES:**
- (E) FC TO REMAIN AS IS.
 - (E) EF TO REMAIN AS IS.
 - (E) SF TO REMAIN AS IS.
 - (E) TSTAT TO REMAIN AS IS.
 - RELOCATED (E) TSTAT, EXTEND CONTROL WIRING AS REQ'D.
 - RELOCATED (E) CD, EXTEND FLEX AS REQ'D.
 - CONN 4\"/>



EXISTING HEAT PUMP SPLIT SYSTEM SCHEDULE															
MARK	HFRG AND MODEL	DISCH	CFM	COOLING CAPACITY			HEATING CAPACITY			ELECTRICAL DATA				OUTDOOR UNIT	
				TOTAL MBH	SEBS MBH	MBH	ELECTRICAL	MAX HP	LBS	MARK	HFRG AND MODEL	ELECTRICAL	REMARKS		
(E) FC-1	TRANE THE036	HORIZ	1200	15	26.6	25	21.2	208/1/60	1/2	40	(E) CU-1	TRANE THA036	480/3/60	225	1
(E) FC-2	TRANE THE049	HORIZ	1500	150	34.3	33.2	21.2	208/1/60	1/2	150	(E) CU-2	TRANE THA049	480/3/60	250	1
(E) FC-3	TRANE THE026	HORIZ	1200	105	26.6	25	21.5	208/1/60	1/2	125	(E) CU-5	TRANE THA026	480/3/60	225	1
(E) FC-4	TRANE THE060	HORIZ	1900	260	44.8	42.4	30.1	208/1/60	3/4	185	(E) CU-4	TRANE THA060	480/3/60	300	1
(E) FC-5	TRANE THE060	HORIZ	2100	225	51.3	44.1	36.4	208/1/60	3/4	185	(E) CU-5	TRANE THA060	480/3/60	300	1
(E) FC-6	TRANE THE045	HORIZ	1600	150	36.8	35.3	19	208/1/60	1/2	150	(E) CU-6	TRANE THA045	480/3/60	250	1
(E) FC-1	TRANE THE030	HORIZ	900	60	21.5	20.4	19	208/1/60	1/3	120	(E) CU-1	TRANE THA030	480/3/60	200	1

1. EXISTING UNITS TO REMAIN AS IS.

SUPPLY FAN SCHEDULE																
MARK	SERVES	HFRG AND MODEL	TYPE	CFM	DTR	ESP IN HG	FAN RPM	MOTOR DATA			DISCONNECT	BACK DRAFT DAMPER	SCORES	HEIGHT	REMARKS	
								SPEED	HATTS	HP						
SP-3	CLASSROOM	COOK GN-622	INLINE	300	--	0.3	1102	F5C	85.5	--	15/1/60	YES	YES	15	30	1, 2, 3
SP-4	STAINED GLASS	COOK GN-622	INLINE	300	--	0.3	1102	F5C	85.5	--	15/1/60	YES	YES	15	30	1, 2, 3

1. BASIS OF DESIGN EQUIPMENT SELECTED AT AN ALTITUDE OF 2500 FEET.
2. PROVIDE MANUFACTURER'S HANGING ISOLATION KIT.
3. PROVIDE INTERMATIC MODEL 5101 7-DAY HEAVY DUTY PROGRAMMABLE TIMER OR EQUAL. FAN TO BE CONTROLLED BY TIMER. FAN TO OPERATE DURING OCCUPIED HOURS.

EXHAUST FAN SCHEDULE																
MARK	SERVES	HFRG AND MODEL	TYPE	CFM	DTR	ESP IN HG	FAN RPM	MOTOR DATA			DISCONNECT	BACK DRAFT DAMPER	SCORES	HEIGHT	REMARKS	
								SPEED	HATTS	HP						
EF-4	GRIND / STAINED GLASS	COOK GN-862	INLINE	1550	--	0.3	1015	F5C	274	--	15/1/60	YES	YES	5.0	65	1, 2, 3
EF-5	FRIT ROOM	COOK GN-622	INLINE	325	--	0.3	1144	F5C	42.2	--	15/1/60	YES	YES	2.0	30	1, 2, 3
EF-6	KILN ROOM	COOK GN-622	INLINE	400	--	0.3	1300	F5C	111	--	15/1/60	YES	YES	2.5	30	1, 2, 3

1. BASIS OF DESIGN EQUIPMENT SELECTED AT AN ALTITUDE OF 2500 FEET.
2. PROVIDE MANUFACTURER'S HANGING ISOLATION KIT.
3. PROVIDE INTERMATIC MODEL 5101 7-DAY HEAVY DUTY PROGRAMMABLE TIMER OR EQUAL. FAN TO BE CONTROLLED BY TIMER. FAN TO OPERATE DURING OCCUPIED HOURS.

MECHANICAL NOTES

PART I - GENERAL:

1.01 - ALL WORK SHALL BE INSTALLED IN ACCORDANCE WITH ALL CODES, LAWS, RULES, AND REGULATIONS OF ALL NATIONAL, STATE, COUNTY, AND LOCAL AUTHORITIES HAVING JURISDICTION OVER THE PREMISES. THIS SHALL INCLUDE, BUT NOT BE LIMITED TO, THE INTERNATIONAL MECHANICAL CODE (IMC 2006), INTERNATIONAL BUILDING CODE (IBC 2006), INTERNATIONAL ENERGY CONSERVATION CODE (IECC 2006), AND THE NATIONAL FIRE PROTECTION ASSOCIATION. IN CASE OF DIFFERENCES, THE MOST RESTRICTIVE OF SAID REGULATIONS SHALL GOVERN. HOWEVER, THIS SHALL NOT BE CONSIDERED TO RELIEVE THIS CONTRACTOR FROM COMPLYING WITH REQUIREMENTS OF THE PLANS AND SPECIFICATIONS WHICH MAY BE IN EXCESS OF CODE REQUIREMENTS.

1.02 - CONTRACTOR TO SECURE AND PAY FOR ALL REQUIRED PERMITS AND INSPECTIONS.

1.03 - FURNISH AND INSTALL ALL EQUIPMENT AND MATERIAL AS SHOWN. THIS SHALL INCLUDE ALL ITEMS NECESSARY TO COMPLETE THE INSTALLATION HEREIN SPECIFICALLY MENTIONED OR NOT.

1.04 - MECHANICAL DRAWINGS ARE DIAGNOMATIC AND INTENDED TO SHOW THE APPROXIMATE LOCATION OF OUTLETS, DUCTWORK, EQUIPMENT, AND PIPING. DIMENSIONS GIVEN IN FIGURE ON THE PLANS SHALL TAKE PRECEDENCE OVER SCALED DIMENSIONS. ALL DIMENSIONS, WHETHER GIVEN IN FIGURES OR SCALED, SHALL BE VERIFIED IN THE FIELD. NO DUCTWORK SHALL BE FABRICATED UNTIL DUCT CLEARANCES ARE FIELD VERIFIED.

1.05 - BEFORE SUBMITTING A BID, CAREFULLY STUDY ALL CONSTRUCTION DOCUMENTS, CAREFULLY EXAMINE THE PROGRESS AND ANY EXISTING WORK. DETERMINE IN ADVANCE THE METHOD OF INSTALLING AND CONNECTING THE EQUIPMENT, AND BE THOROUGHLY FAMILIAR WITH ALL THE REQUIREMENTS OF THE CONTRACT.

1.06 - BY THE ACT OF SUBMITTING A PROPOSAL FOR THE WORK REQUIRED AND INCLUDED IN THE CONTRACT, THE CONTRACTOR SHALL BE DEEMED TO HAVE MADE SUCH STUDY AND EXAMINATION AND TO BE FAMILIAR WITH AND ACCEPT ALL CONDITIONS OF THE SITE.

1.07 - THE MECHANICAL SYSTEMS HAVE BEEN DESIGNED AROUND THE MAKES AND SIZES OF EQUIPMENT NAMED IN THE EQUIPMENT SCHEDULES AND SHOWN ON THE DRAWINGS. OTHER MAKES OF EQUIPMENT NAMED IN THIS SPECIFICATION SHOWN ON THE DRAWINGS, OR APPROVED BY THE ARCHITECT MAY BE FURNISHED AT THIS CONTRACTOR'S OPTION. IT IS, HOWEVER, THIS CONTRACTOR'S RESPONSIBILITY TO BE SURE THAT SUCH EQUIPMENT HAS EQUIVALENT CAPACITY, THE SAME ELECTRICAL CHARACTERISTICS, SUBSTANTIALLY THE SAME PHYSICAL DIMENSIONS AND CAN BE INSTALLED IN THE SPACE AVAILABLE WITH AMBLE WORKING SPACE AROUND IT. ANY ADDITIONAL COSTS RESULTING FROM EQUIPMENT OR MATERIAL SUBSTITUTION SHALL BE BORNE BY THIS CONTRACTOR.

1.08 - THE FOLLOWING IS A LIST OF ADDITIONAL EQUIPMENT APPROVED FOR USE ON THIS PROJECT SUBJECT TO SECTION 1.06 ABOVE:

1. EXHAUST FANS: GREENHECK, COOK, THIN CITY
2. AIR DEVICES: KRUEGER, TITUS, NALOR, RUSKIN, PRICE, TUTTLE & BAILEY

1.09 - THE CONTRACTOR SHALL SUBMIT AN ELECTRONIC COPY OF SHOP DRAWINGS ON THE FOLLOWING ITEMS:

1. AIR DEVICES
2. EXHAUST FANS

1.10 - PROVIDE ALL OPENINGS THROUGH THE WALLS OR ROOF.
1.11 - ELECTRICAL HIGH VOLTAGE POWER WIRING, CONDUIT, DISCONNECT SWITCHES, FUSES, ETC., SHALL BE FURNISHED AND INSTALLED BY THE ELECTRICAL CONTRACTOR.

PART II - ERECTION:

2.01 - FURNISH AND INSTALL THE EQUIPMENT AND MATERIAL OF THE SIZE, QUALITY, CAPACITY AND PERFORMANCE INDICATED. THE EQUIPMENT SHALL BE NEW WITH THE MAKE, MODEL NUMBER, SIZE OR CAPACITY STAMPED ON IT OR ON A NAMEPLATE AFFIXED THERE TO.

2.02 - PROVIDE CURBS AND FLASHINGS WHERE DUCTWORK PASSES THROUGH THE ROOF.

2.03 - THE CONTRACTOR IS RESPONSIBLE FOR BACK CHECKING THE ARCHITECTURAL DRAWINGS AND EXAMINING THE WALL/CILING TYPES TO ENSURE PROPER INSTALLATION OF FIRE/FIRE SMOKE DAMPERS.

2.04 - EQUIPMENT SHALL BE INSTALLED TO PERMIT ACCESS FOR SERVICE AND MAINTENANCE. ALL EQUIPMENT SHALL BE INSTALLED AS RECOMMENDED BY THE EQUIPMENT MANUFACTURERS.

2.05 - BALANCE ALL AIR QUANTITIES AS INDICATED ON THE DRAWINGS (1) OR (2) JOB, IN ACCORDANCE WITH SHAKMA OR ARIE BALANCING PROCEDURES. SUBMIT AN ELECTRONIC COPY OF THE BALANCE REPORTS INCLUDING EQUIPMENT VOLTAGE AND AMP READINGS. AN AGENCY INDEPENDENT OF CONTRACTOR SHALL DO THE BALANCING. FINAL AIR BALANCE REPORT SHALL BE SUBMITTED TO THE MECHANICAL INSPECTOR PRIOR TO CALLING FOR FINAL INSPECTION.

2.06 - AT ALL TIMES, KEEP THE BUILDING AND PREMISES IN A NEAT MANNER. THOROUGHLY CLEAN UP AT END OF CONSTRUCTION.






2.07 - RECORD ALL CHANGES FROM CONTRACT DRAWINGS INCLUDING "FOUND" CONDITIONS AND SEND TO ARCHITECT RECORD DRAWINGS AT CLOSE OF PROJECT.

2.08 - FILTERS TO BE MINIMUM MERV-8. INSTALL A NEW SET OF FILTERS AFTER FINAL INSPECTION.

2.09 - FURNISH TO THE ARCHITECT AN ELECTRONIC FILE OF THE OPERATING AND MAINTENANCE MANUALS. MANUALS SHALL CONTAIN MANUFACTURER'S GUTS, SPARE PARTS LIST, SEQUENCE OF OPERATION, AND A PREVENTATIVE MAINTENANCE SCHEDULE.

2.10 - GUARANTEE WORK TO BE FREE FROM DEFECTS IN WORKMANSHIP AND MATERIAL FOR A PERIOD OF ONE YEAR FROM THE DATE OF FINAL ACCEPTANCE.

END OF SPECIFICATIONS

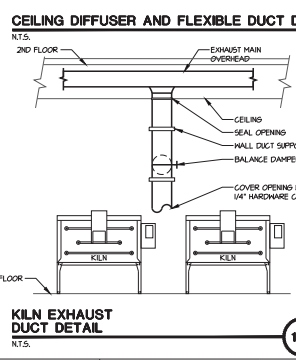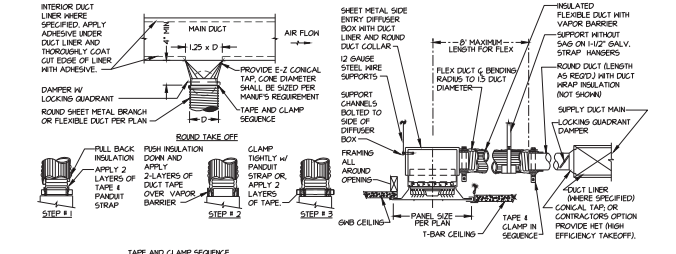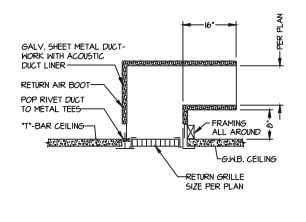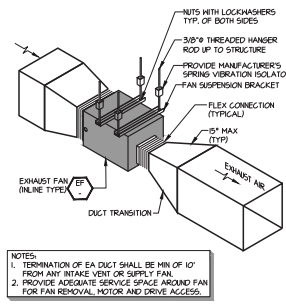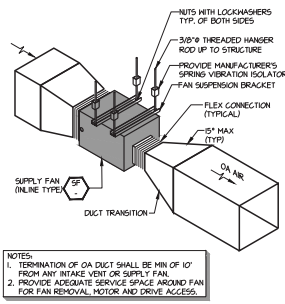

SUPPLY FAN - INLINE
NTS.

EXHAUST FAN - INLINE
NTS.

RETURN AIR BOOT DETAIL
NTS.

CEILING DIFFUSER AND FLEXIBLE DUCT DETAIL
NTS.

KILN EXHAUST DUCT DETAIL
NTS.




Glass Arts Tl at Santa Rita Springs
Green Valley Rehabilitation
921 W. Rio Florido, Green Valley, AZ 85614

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			FIELD BOOK

MECHANICAL NOTES, SCHEDULES, & DETAILS
M2.0



PLUMBING LEGEND & SYMBOLS	
—S	SEWER LINE
—S	(S) SEWER LINE
—V	VENT LINE
—V	(S) VENT LINE
—C	COLD WATER LINE
—C	(S) COLD WATER LINE
—H	HOT WATER LINE
—H	(S) HOT WATER LINE
—H	HOT WATER RETURN LINE
—C	CONDENSATE LINE
—C	(S) CONDENSATE LINE
—F	FIRE PROTECTION
—S.O.V.	SHUT OFF VALVE (BALL VALVE)
○	WALL CLEAN-OUT
○	RISER, WASTE/VENT
○	RISER, CAPED U/S
○	90° ELBOW
○	90° ELBOW DN
○	90° ELBOW UP
○	TEE
○	TEE DN
○	TEE UP
○	REDUCER
○	UNION
○	Y-STRAINER
○	HOSE BIBS
○	INDIRECT DRAIN
○	GATE VALVE
○	GLOBE VALVE
○	CHECK VALVE
○	WALL WATER HAMMER ARRESTOR
○	POINT OF NEH CONNECTION (P.O.C.)
○	KEYNOTE TAG
○	EQUIPMENT TAG
○	DETAIL CALL-OUT
○	ISOMETRIC CALL-OUT ARROW POINT IN DIRECTION OF VIEW
ADV	ABOVE
FFE	FINISH FLOOR ELEVATION
AC	AIR CONDITIONING
DN	DOWN
(E) EXIST.	EXISTING
VR	VENT THRU ROOF
W	WITH
W	WALL CLEANOUT
DN	OVERHEAD
U.S.	UNDER GROUND
TRH	PIPE THRU HALL
TRR	PIPE THRU ROOF
ECO	GRADE CLEANOUT
FSD	FLOOR CLEANOUT
CI	CAST IRON
ID	INDIRECT WASTE
UNC.	UNLESS NOTED OTHERWISE
MBH	THOUSAND BTUS PER HOUR

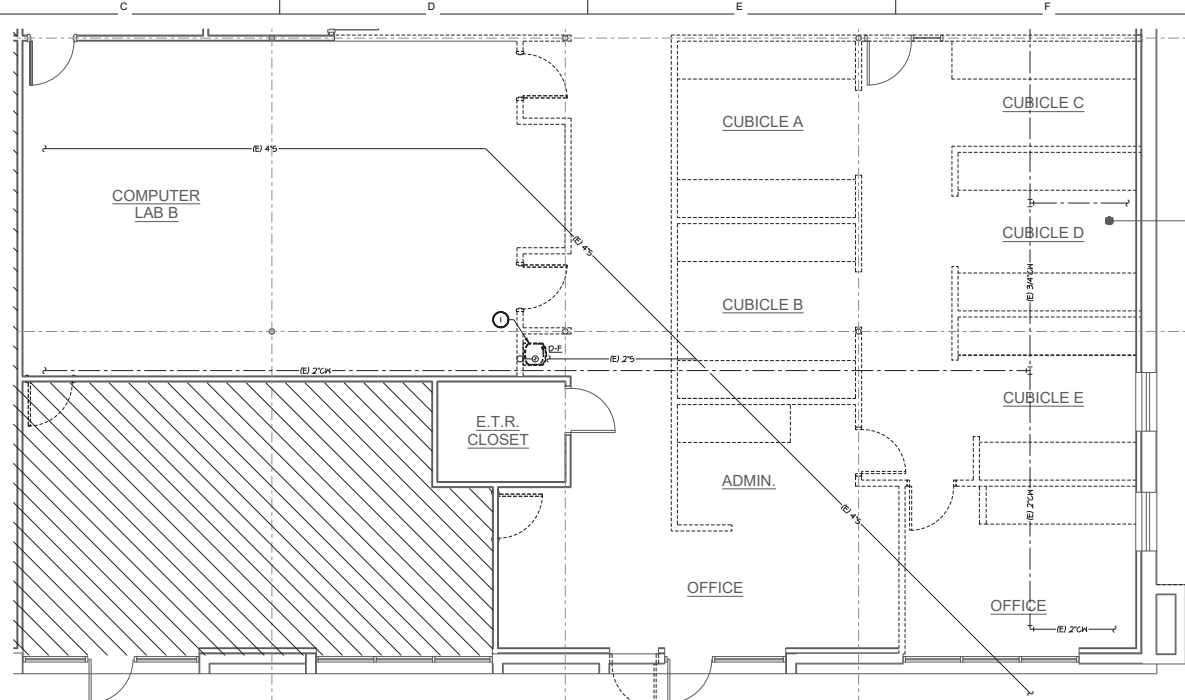

1 PLUMBING DEMO PLAN - 1ST LEVEL
1/4" = 1'-0"

PLUMBING DEMOLITION NOTES

- COORDINATE DEMOLITION OF ALL OVERHEAD, IN HALL, AND BELOW FLOOR PLUMBING ITEMS WITH OTHER TRADES.
- COORDINATE DEMOLITION SCHEDULE AND HOURS OF WORK WITH THE OWNER AND/OR ARCHITECT.
- CONTRACTOR SHALL MAINTAIN PREMISES IN CLEAN CONDITION AT END OF EACH DAY AND THOROUGHLY CLEANUP AT END OF CONSTRUCTION.
- COORDINATE PROPER DISPOSAL OF ALL DEMOLITION ITEMS WITH OTHER TRADES/ARCHITECT.
- ALL PLUMBING EQUIPMENT AND PIPING HAS BEEN SHOWN BASED UPON CURRENT AVAILABLE DRAWINGS AND NON INVASIVE SITE INSPECTIONS. IF PIPING AND EQUIPMENT IS NOT ACCORDING TO THE DRAWING CONTACT ARCHITECT/ENGINEER FOR DIRECTION. ADDITIONAL DEMOLITION THAT MAY RESULT WILL NOT CONSTITUTE AN ADDITIONAL COST TO THE PROJECT.

GENERAL NOTES:

- CONTRACTOR MUST VERIFY EXISTING WASTE PIPING LOCATIONS AND SIZES AND VERIFY NEW WASTE PIPING CAN BE INSTALLED WITH THE PROPER SLOPE BEFORE BEGINNING WORK.
- CONTRACTOR MUST VERIFY EXISTING WATER SUPPLY PIPING AND LOCATIONS BEFORE BEGINNING WORK.

KEYNOTES:


- DEMO FIXTURE SHOWN DASHED. CAP WASTE PIPING BELOW FLOOR. CAP WATER AND VENT PIPING IN CLS. SPACE.



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ISSUE DATE	11/06/22
PROJECT NUMBER	217203100
FIELD BOOK	



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1 PLUMBING WASTE PLAN - 1ST LEVEL
1/4" = 1'-0"

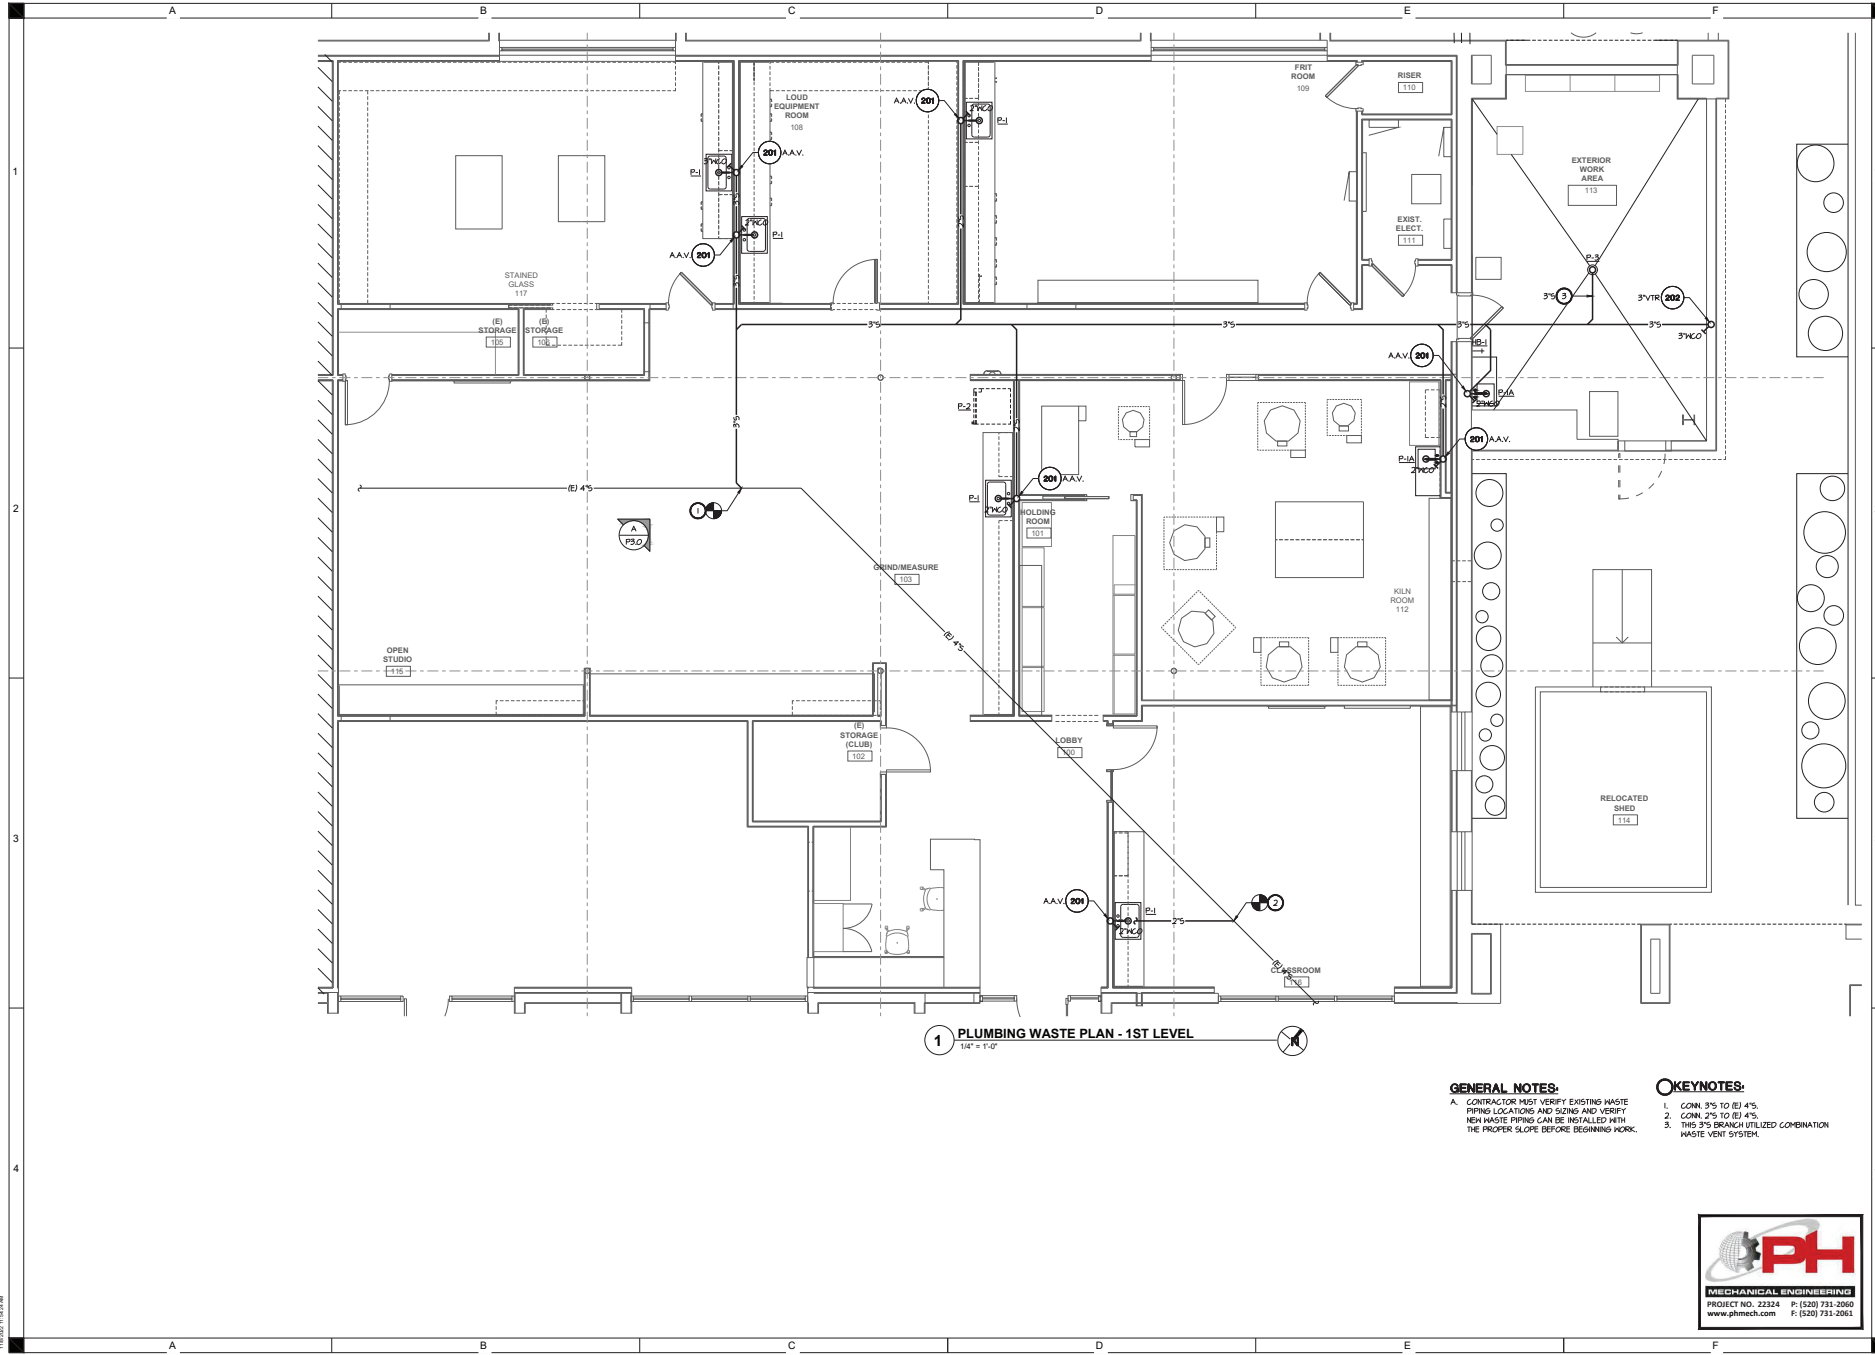GENERAL NOTES:
 A. CONTRACTOR MUST VERIFY EXISTING WASTE PIPING LOCATIONS AND SIZES AND VERIFY NEW WASTE PIPING CAN BE INSTALLED WITH THE PROPER SLOPE BEFORE BEGINNING WORK.

KEYNOTES:
 1. COM. 3/8 TO EJ 4/8.
 2. COM. 2/5 TO EJ 4/8.
 3. THIS 3/8 BRANCH UTILIZED COMBINATION WASTE VENT SYSTEM.




W&M ARCHITECTS
 A DIVISION OF SHIVE-HATTERY
 4330 N. CAMPBELL AVE. STE. 100B
 GREEN VALLEY, AZ 85614
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Glass Arts TI at Santa Rita Springs
 Green Valley, AZ
 921 W. Via Rio Events, Green Valley, AZ 85614

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PLUMBING WASTE FLOOR PLAN
P1.0



1 PLUMBING WATER PLAN - 1ST LEVEL
1/4" = 1'-0"


GENERAL NOTES:
A. CONTRACTOR MUST VERIFY EXISTING WATER SUPPLY PIPING AND LOCATIONS, BEFORE BEGINNING WORK.

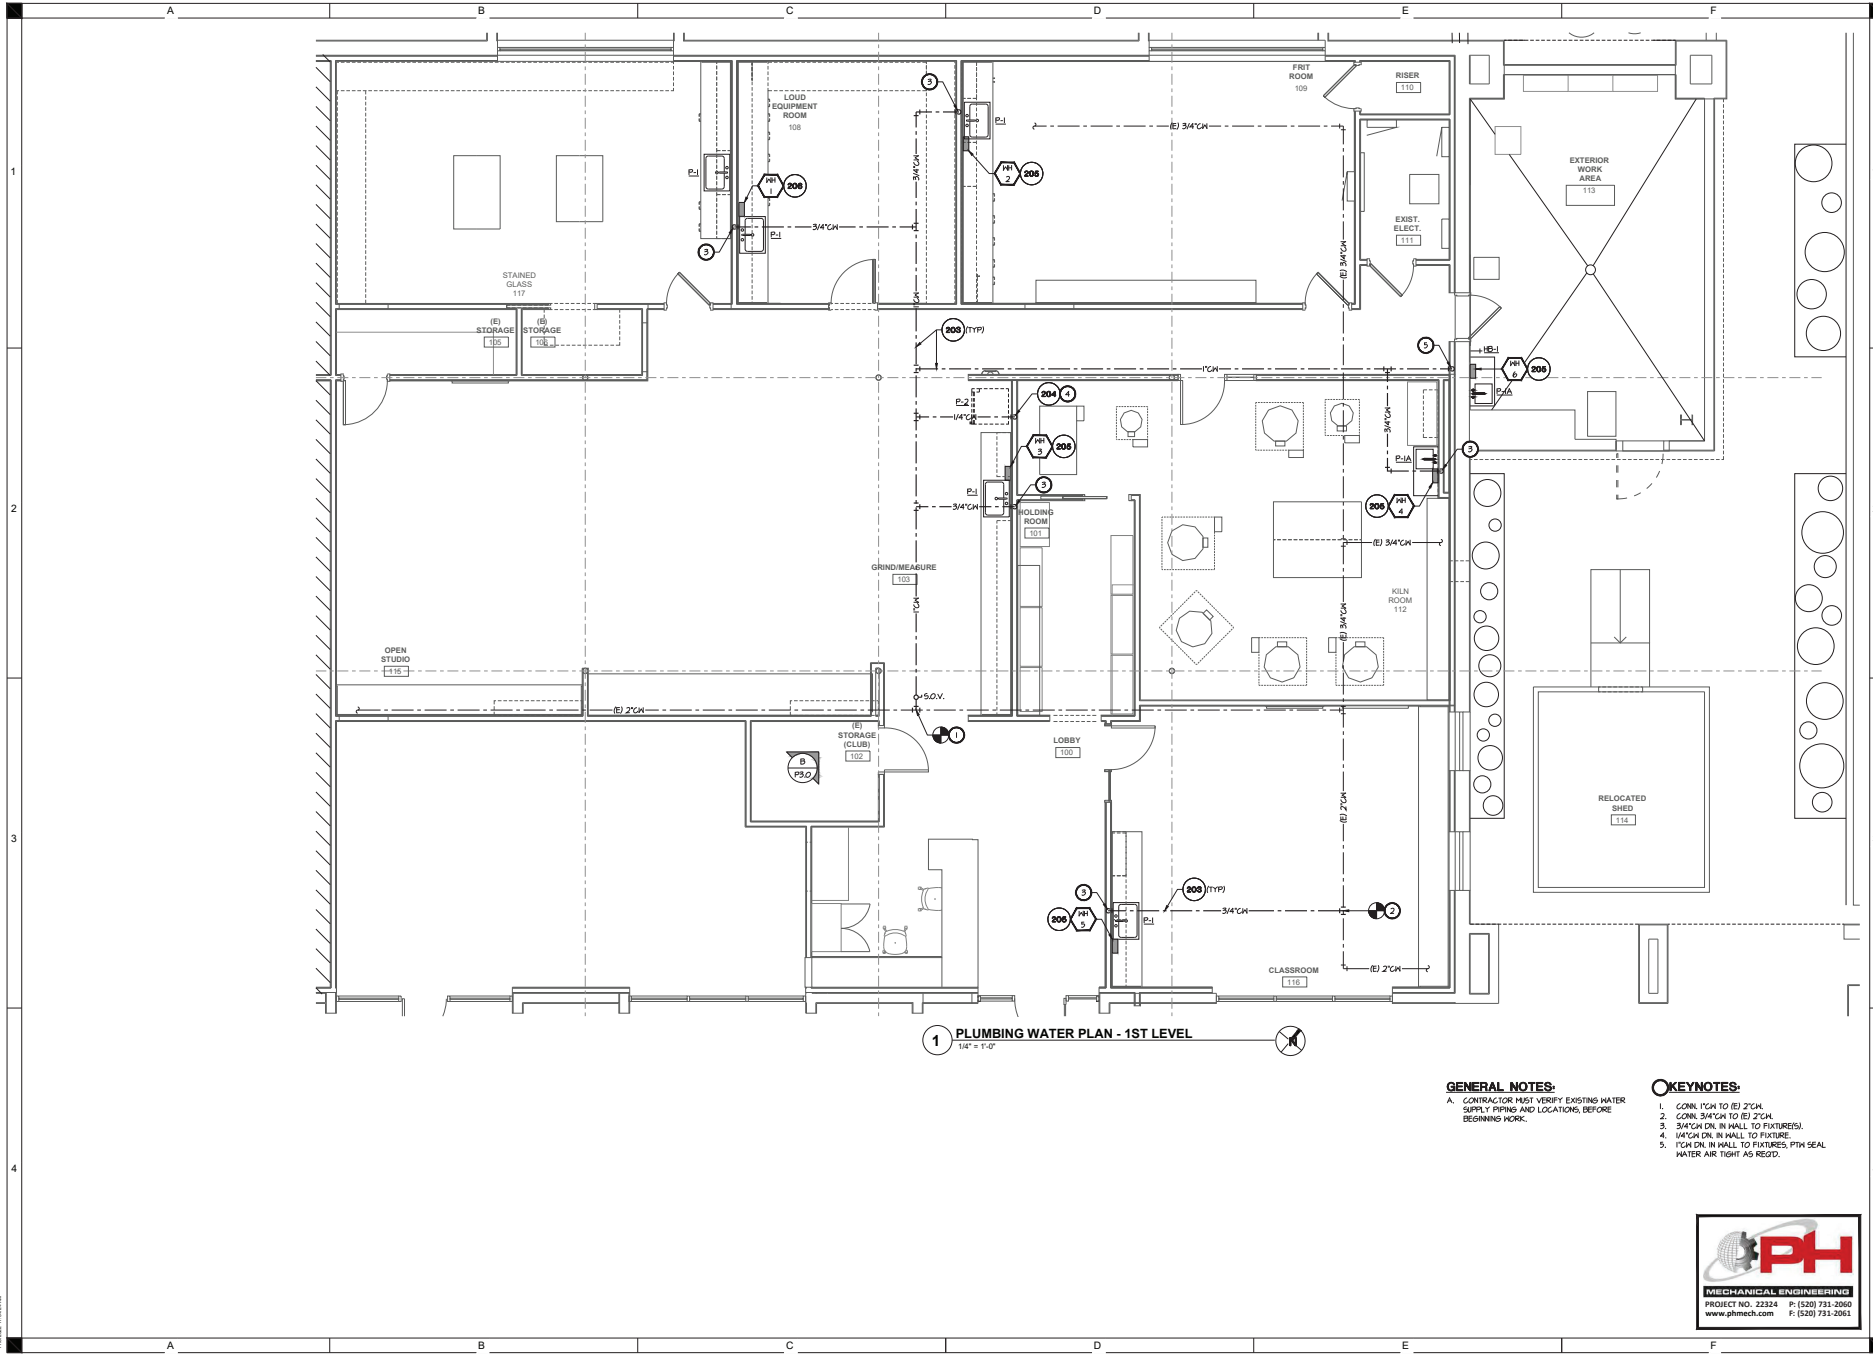- KEYNOTES:**
1. CONN. PCH TO (E) 2" CH.
 2. CONN. 3/4" CH TO (E) 2" CH.
 3. 3/4" CH DN. IN HALL TO FIXTURE(S).
 4. 1/4" CH DN. IN HALL TO FIXTURE.
 5. PCH DN. IN HALL TO FIXTURES, PTH SEAL WATER AIR TIGHT AS REQD.

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MECHANICAL ENGINEERING
PROJECT NO. 22324 P: (520) 731-2060
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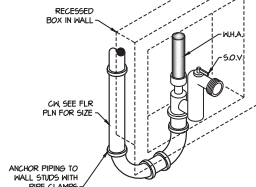
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NOTES:
 A. COOR. W/ ELEC. CONTRACTOR TO MINIMIZE THE AMOUNT OF EXPOSED CONDUIT UNDER SINKLAV.
 B. PLUMBING CONTR. TO MINIMIZE THE AMOUNT OF PIPING EXPOSED UNDER THE SINK. ROUTE IN WALL AS HIGH AS POSSIBLE.

INSTANTANEOUS ELEC. WATER HEATER DETAIL
 N.T.S.


205

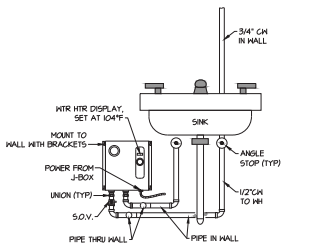

FOR NON RATED HALLS: DATEY 38570 ICE MAKER OUTLET BOX W/ WATER HAMMER ARRESTOR & S.O.V.
 FOR RATED HALLS: DATEY 38121 FIRE RATED ICE MAKER OUTLET BOX W/ WATER HAMMER ARRESTOR & S.O.V.


REFRIGERATOR RECESSED BOX W/ W.H.A. AND S.O.V. DETAIL
 N.T.S.

204

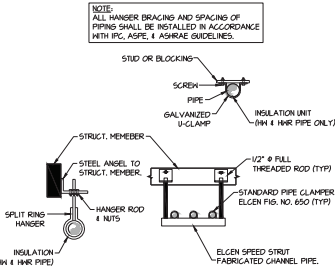

PIPE SUPPORT DETAIL
 N.T.S.


203

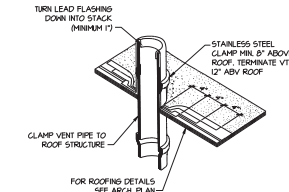

NOTES:
 PLUMBING CONTRACTOR SHALL BE RESPONSIBLE FOR OFFSETTING VENTS AS REQUIRED TO MAINTAIN 10\"/>

VENT THRU ROOF DETAIL
 N.T.S.

202

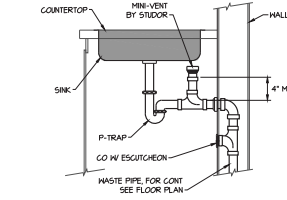


AIR ADMITTANCE VALVE VENT DETAIL
 N.T.S.

201


GENERAL ISOMETRIC NOTE:
 A. SEE PLUMBING SCHEDULE FOR INDIVIDUAL FIXTURE WASTE & VENT SIZE.
 B. SEE PLUMBING SCHEDULE FOR INDIVIDUAL FIXTURE CROWN PIPE SIZE.
 C. IF S.O.V.'S ARE LOCATED ABOVE HARD CEILING, PROVIDE ACCESS PANELS AS NOTED, COORDINATE WITH ARCHITECT.
 D. PROVIDE S.O.V.'S ON CROWN PIPES TO ISOLATE GROUPS OF FIXTURES, EVEN IF NOT SHOWN ON THESE PLANS.

- KEYNOTES:**
1. CONN. 1/2\"/>

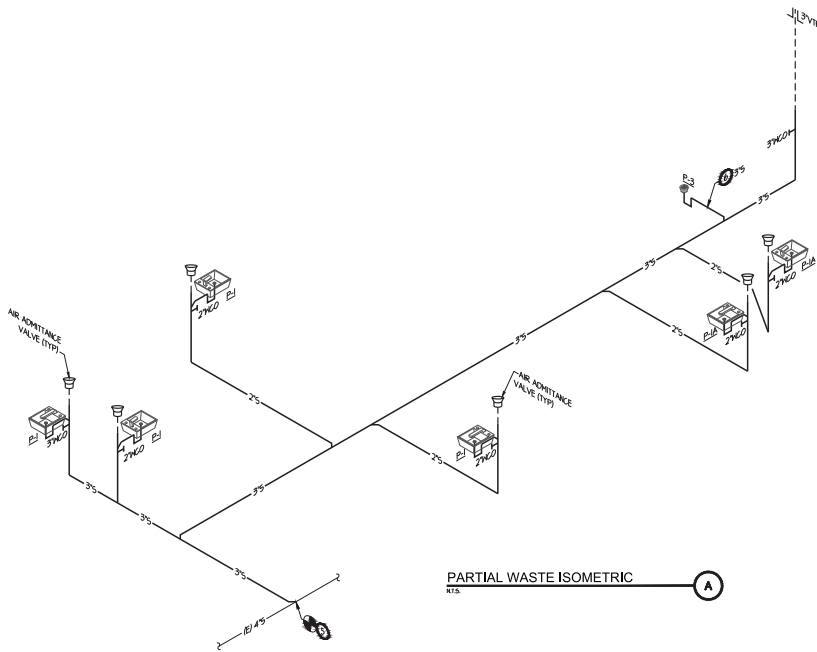


PARTIAL WASTE ISOMETRIC
 N.T.S.

A

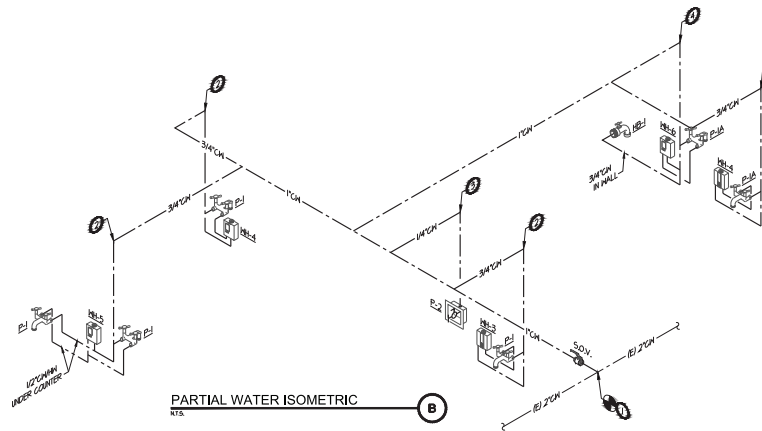

PARTIAL WATER ISOMETRIC
 N.T.S.

B

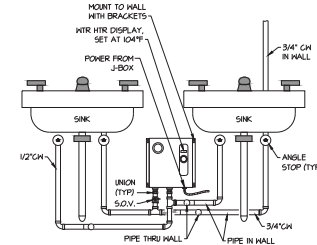

NOTES:
 A. COOR. W/ ELEC. CONTRACTOR TO MINIMIZE THE AMOUNT OF EXPOSED CONDUIT UNDER SINKLAV.
 B. PLUMBING CONTR. TO MINIMIZE THE AMOUNT OF PIPING EXPOSED UNDER THE SINK. ROUTE IN WALL AS HIGH AS POSSIBLE.

INSTANTANEOUS ELEC. WATER HEATER DETAIL
 N.T.S.

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PLUMBING PLAN NOTES

- PART 1 GENERAL REQUIREMENTS:**
- 1.01 ALL WORK SHALL BE INSTALLED IN ACCORDANCE WITH ALL CODES, LAWS, RULES AND REGULATIONS OF ALL NATIONAL, COUNTY, STATE AND LOCAL AUTHORITIES HAVING JURISDICTION OVER THE PREMISES. THIS SHALL INCLUDE, BUT NOT BE LIMITED TO, THE 2008 INTERNATIONAL PLUMBING CODE (IPC 10), THE INTERNATIONAL BUILDING CODE AND THE INTERNATIONAL FIRE PROTECTION ASSOCIATION. IN CASE OF DIFFERENCES, SAID REGULATIONS SHALL GOVERN. HOWEVER, THIS SHALL NOT BE CONSTRUED TO RELIEVE THE CONTRACTOR FROM COMPLYING WITH REQUIREMENTS OF THE PLANS AND SPECIFICATIONS, WHICH MAY BE IN EXCESS OF REQUIREMENTS.
 - 1.02 PLUMBING DRAWINGS ARE DIAGNOMATIC AND ARE INTENDED TO SHOW THE APPROXIMATE LOCATION OF FIXTURES, EQUIPMENT AND PIPING. DIMENSIONS GIVEN IN FIGURES ON THE PLANS SHALL TAKE PRECEDENCE OVER SCALED DIMENSIONS AND ALL DIMENSIONS WHETHER GIVEN IN FIGURES OR SCALED, SHALL BE VERIFIED IN THE FIELD.
 - 1.03 BEFORE SUBMITTING A BID, THE CONTRACTOR SHALL CAREFULLY STUDY THE MECHANICAL AND PLUMBING DRAWINGS AND ALL ASSOCIATED CONSTRUCTION DOCUMENTS. HE SHALL ALSO MAKE A CAREFUL EXAMINATION OF THE PREMISES AND ANY EXISTING CONDITIONS, INCLUDING INVERTS TO ENSURE PROPER SLOPE MAY BE OBTAINED. HE SHALL DETERMINE, IN ADVANCE, THE METHODS OF INSTALLING AND CONNECTING THE APPARATUS, THE HEADS TO BE PROVIDED FOR SETTING THE EQUIPMENT INTO PLACE, AND SHALL MAKE HIMSELF THOROUGHLY FAMILIAR WITH ALL OF THE REQUIREMENTS OF THE CONTRACT.
 - 1.04 BY THE ACT OF SUBMITTING A PROPOSAL FOR THE WORK REQUIRED AND INCLUDED IN THE CONTRACT, THE CONTRACTOR SHALL BE DEEMED TO HAVE MADE SUCH STUDY AND EXAMINATION, AND TO BE FAMILIAR WITH AND ACCEPT ALL CONDITIONS OF THE SITE.
 - 1.05 MAKE ARRANGEMENTS FOR AND PAY FOR ALL FEES, PERMITS, LICENSES, CONNECTION CHARGES AND INSPECTIONS REQUIRED FOR PLUMBING WORK. PERFORM REQUIRED TESTS AND SECURE REQUIRED INSPECTIONS PRIOR TO BACK-FILLING.
 - 1.06 NRIAP ALL PIPING IN BLOCK WALLS OR PENETRATING CONCRETE WITH 10 MIL POLYETHYLENE TAPE.
 - 1.07 CONTRACTOR SHALL FURNISH ANY MISCELLANEOUS ITEMS NORMALLY USED, SPECIFICALLY MENTIONED OR NOT, TO RENDER A COMPLETE INSTALLATION.
 - 1.08 ALL EQUIPMENT SHALL BE INSTALLED PER MANUFACTURER'S REQUIREMENTS. EQUAL EQUIPMENT MAY BE USED ON THE PROJECT. IT IS THE CONTRACTOR'S RESPONSIBILITY TO CONFIRM THAT SUCH EQUIPMENT HAS EQUAL CAPACITY, THE SAME ELECTRICAL CHARACTERISTICS, AND SUBSTANTIALLY THE SAME PHYSICAL DIMENSIONS AND CAN BE INSTALLED IN THE SPACE AVAILABLE WITH ANGLE WORKING SPACE AROUND IT. ANY EXTRA COSTS RESULTING FROM EQUIPMENT SUBSTITUTION SHALL BE BORNE BY THIS CONTRACTOR.
 - 1.09 PER SECTION 402.3.4 OF THE IPC: UPON COMPLETION OF DOMESTIC WATER, PERFORM A STERILIZATION OF THE DOMESTIC WATER SYSTEM OR THE PART THEREOF. THE SYSTEM OR THE PART THEREOF SHALL BE FILLED WITH A WATERBORNE SOLUTION CONTAINING AT LEAST 50 PPM OF GARDOLINE, AND THE SYSTEM OR PART THEREOF SHALL BE VALVED OFF AND ALLOWED TO STAND FOR 24 HOURS. OR THE SYSTEM OR THE PART THEREOF SHALL BE FILLED WITH A WATERBORNE SOLUTION CONTAINING 200 PPM OF GARDOLINE AND ALLOWED TO STAND FOR 3 HOURS. FOLLOWING THE REQUIRED STANDING TIME, THE SYSTEM SHALL BE FLUSHED WITH CLEAN POTABLE WATER UNTIL THE GARDOLINE IS PURGED FROM SYSTEM. START AND FINISH INSPECTIONS SHALL BE PERFORMED BY THE OWNER'S REPRESENTATIVE. CONTRACTOR SHALL PROVIDE DOCUMENTATION FOR ENGINEER AND INSPECTOR BY AN APPROVED AGENCY (A BACTERIOLOGICAL EXAMINATION) THAT NO CONTAMINATION PERSISTS IN THE SYSTEM.

PLUMBING FIXTURES SCHEDULE AND SPECIFICATIONS

MARK	EQUIPMENT	WATER FIXTURE UNITS		HW FIXTURE UNITS		WASTE FIXTURE UNITS		FIXTURE CONNECTION SIZES										REMARKS
		QTY	FU	TOTAL FU	FU	TOTAL FU	FU	TOTAL FU	WASTE RISER	TRAP ARM	W/CO SIZE	V	CH	HH	FIXTURE NOTES			
P-1	SINKLE COMP COUNTER MOUNTED	5	2	10	15	2	10	2"	2"	2"	1-1/2"	1/2"	1/2"	1/2"	BASIN ELKAY, CELEBRITY SINKS, MODEL #SEC2021, 25" x 21-1/4" x 5-3/8" FAUCET, ELKAY MODEL #LK30M4014, DECK MOUNTED FAUCET	L		
P-1A	UTILITY SINK	2	3	6	2.25	4.50	2	4	2"	2"	2"	1-1/2"	3/4"	3/4"	BSOT, FREE STANDING STAINLESS-STEEL SINK, MODEL NO. B0B074040K, FAUCET, KRAS, SINGLE-HANDLE FALL-DOWN SPRAYER FAUCET, MODEL K9F-660.	L		
P-2	REFRIGERATOR	1	5	0.5	-	-	-	-	-	-	-	-	1/4"	-	OTHER SPECIFIED, AND CONTRACTOR INSTALLED, PROVIDE RECESSED BOX W/ 5.0.V.	1,2,3		
P-3	FLOOR DRAIN	1	-	-	-	-	2	2	2"	2"	-	1-1/2"	-	-	DRN MODEL 2-415-58, FLOOR DRAIN WITH DURACOATED CAST IRON BODY WITH 2" BOTTOM OUTLET, COMBINATION INVERTIBLE MEMBRANE CLAMP AND ADJUSTABLE COLLAR W/ TYPE B' NICKEL BRONZE DRAINER.	L		
HD-1	HOSE BIBB	1	25	25	-	-	-	-	-	-	-	-	3/4"	-	WOODFORD MODEL 40HT BRASS ADA HALL FAUCET W/ OPTIONAL LEVER HANDLE	L		
NEXT FIXTURES TOTAL				19.0		12.0		16.0										
EXISTING FIXTURES TOTAL				42.0		0.0		0.0										
PROJECT TOTAL				61.0		12.0		16.0										

- REMARKS:**
- CONTRACTOR TO PROVIDE ALL NECESSARY PARTS FOR A COMPLETE INSTALLATION.
 - SEE ARCHITECTURAL DRAWINGS FOR SPECIFICATION.
 - SHALL BE THIRD PARTY LISTED, REFERENCE SECTIONS 303.4 & 402.1020B.

FIRE PROTECTION NOTES

- THE FIRE PROTECTION CONTRACTOR SHALL MODIFY THE EXISTING AUTOMATIC WET SPRINKLER SYSTEM AND PROVIDE ALL NECESSARY MODIFICATIONS AS REQUIRED TO MAINTAIN A CODE COMPLIANT FIRE PROTECTION SYSTEM BASED UPON THE NEW CONSTRUCTION.
- SYSTEM TO BE DESIGNED FOR THE HAZARD OCCUPANCY AND DENSITY EQUAL TO THE EXISTING SYSTEM. SUBMIT SHOP DRAWINGS AND EQUIPMENT LITERATURE FOR REVIEW AND APPROVAL BY THE FIRE DEPARTMENT, LOCAL AUTHORITY AND ARCHITECT/ENGINEER.
- ALL SYSTEM PIPING SHALL BE CONCEALED UNLESS OTHERWISE NOTED. CONTRACTOR SHALL NOTIFY THE ARCHITECT IN WRITING IF PIPING CANNOT BE CONCEALED. COORDINATE HEAD AND PIPE LOCATION WITH CEILING GRID PATTERN, AIR CONDITIONS DUCT WORK, AND WORK OF OTHER TRADES.
- ALL HANGERS, HANGERS SPACING, SHAY BRACING AND SHAY BRACE SPACING TO MEET REQUIREMENTS OF THE LATEST ADOPTED EDITION OF NFPA-13.
- SPRINKLER HEADS TO BE IN ACCORDANCE WITH NFPA-13 FOR THE USE REQUIRED AND TO MATCH EXISTING HEADS. CENTER HEADS IN AT LEAST ONE-DIRECTION IN CEILING TILES. PROVIDE SPARE SPRINKLER HEADS AS REQUIRED BY NFPA-13.
- ALL FIRE PROTECTION MODIFICATIONS SHALL MEET ALL CURRENT NFPA CODES AND LOCAL FIRE MARSHAL/ADMINISTRATIVE AUTHORITY REQUIREMENTS.
- COORDINATE THE DESIGN WITH THE INSURANCE UNDERWRITER FOR ANY REQUIREMENTS ABOVE AND BEYOND THE PREVIOUSLY MENTIONED REQUIREMENTS.
- THIS CONTRACTOR SHALL FIELD VERIFY ALL EXISTING CONDITIONS PRIOR TO THE BIDDING. NOTIFY THE ARCHITECT/ENGINEER OF ANY CONFLICTS WHICH MAY AFFECT THE SCOPE OF WORK.
- FIRE PROTECTION CONTRACTOR TO REPLACE FIRE SPRINKLERS IN THE KLN ROOM WITH HIGH TEMPS HEADS.

INSTANTANEOUS WATER HEATER SCHEDULE

MARK	ELECTRIC WATER HEATER (WH)						REMARKS
	WHR	MODEL	TYPE	PERFORMANCE	HIG. ELEM.	ELEC. 4 BREAKER SIZE	
WH-1	EEHAX	SPEX20T	58K	1.6HP 55" RISE	8 KH	27W/6 24 AMPS	-
WH-12-63	EEHAX	SPEX42TT	58K	1.6HP 28" RISE	4J KH	27W/6 15 AMPS	-

PIPE MATERIAL SCHEDULE

PIPING SYSTEM	ABBREVIATION	PIPING MATERIAL
SANITARY DRAINAGE & VENT (ABOVE & BELOW GRADE)	SV	HUBLESS CAST IRON, ABS, OR PVC
POTABLE WATER ABOVE GRADE	CH, HH	TYPE L HARD DRAWN COPPER
FIRE PROTECTION (ABOVE GRADE)	FP	SCHEDULE 40 OR 40 BLACK STEEL

- GENERAL NOTES:**
- REFER TO SPECIFICATIONS FOR FITTINGS, INSTALLATION REQUIREMENTS AND FURTHER INFORMATION.
 - NO PLASTIC (ABS, OR PVC) PIPING TO BE ALLOWED IN RETURN AIR PLENUM.
 - WASTE PIPING 2" SMALLER TO SLOPE AT 1/4 IN. FT. 3" & LARGER TO SLOPE 1/8" IN. FT. UNDO.
 - ANY PIPING IN FIRE WALLS, IN RETURN AIR PLENUM OR EXPOSED TO OUTSIDE ELEMENTS SHALL BE CAST IRON OR COPPER.
 - PENETRATIONS THRU WALLS MUST BE SEALED WITH FIRE STOPS CONFORMING TO LATEST I.B.C.



Glass Arts T1 at Santa Rita Springs

Green Valley Recreation
921 W. Via Rio Fuertes, Green Valley, AZ 85614

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PLUMBING SCHEDULES & NOTES
P4.0

ELECTRICAL NOTES

- 1. COMPLY WITH OR EXCEED THE REQUIREMENTS OF THE LATEST EDITION OF THE NATIONAL ELECTRICAL CODE, AND APPLICABLE LOCAL, STATE, AND FEDERAL ORDINANCES. OBTAIN ALL REQUIRED STATE AND LOCAL PERMITS AND ASSOCIATED FEES.
2. COMPLY WITH ARIZONA REVISED STATUTES TITLE 44, CHAPTER 9, AS AMENDED BY ARTICLE 19.
3. VERIFY CEILING SYSTEM COMPATIBILITY WITH LIGHTING FIXTURES BEFORE RELEASING FIXTURE ORDER.
4. FLUSHMOUNT WIRING DEVICES, SWITCHES, RECEPTACLES, ETC., UNO
5. COVER PLATES SHALL BE SEMI-RIGID, HIGH IMPACT, NYLON.
6. ILLUMINATED EXIT SIGNS SHALL HAVE AN INPUT POWER DEMAND OF FIVE WATTS OR LESS PER ILLUMINATED FACE AND SHALL EITHER HAVE A POWER FACTOR OF AT LEAST 0.70 OR MEET THE POWER FACTOR PRODUCT SPECIFICATION OF THE ENERGY STAR PROGRAM REQUIREMENTS, WHICHEVER IS HIGHER.
7. COORDINATE WITH OTHER TRADES TO AVOID CONFLICTS AND TO VERIFY EQUIPMENT CONNECTIONS, AND FOR COMPLETE INSTALLATION AND CONNECTION.
8. INSTALL A COMPLETE ELECTRICAL SYSTEM PER CONTRACT DRAWINGS AND ENSURE THAT THE SYSTEM IS OPERATIONAL UPON JOB COMPLETION.
9. COORDINATE ALL WIRING DEVICE LOCATIONS AND ELEVATIONS INDICATED ON PLANS WITH THE OWNER, ARCHITECT AND FINAL FURNITURE/EQUIPMENT LAYOUTS.
10. A) FURNISH AND INSTALL ALL BRANCH CIRCUIT WIRING IN ACCORDANCE WITH NATIONAL ELECTRICAL CODE AND THIS DRAWING.
B) MAXIMUM LOAD PER 20A/1P CIRCUIT: 1920 WATTS (120V); 4400 WATTS (277V).
C) VOLTAGE DROP SHALL BE LIMITED TO 3% ON ALL BRANCH CIRCUITS.
11. A) INSTALL CONDUIT WITH SIZES AS INDICATED OR REQUIRED RIGIDLY SECURED IN PLACE WITH NOT LESS THAN 3/16" WALLESS, CORROSION PROOF, ALLOY STRAP OR HANGER PER EIGHT FEET OF CONDUIT. PERFORATED STRAPPING IS NOT ACCEPTABLE.
B) SUPPORT CONDUITS FROM STRUCTURAL SLABS, WALLS, STRUCTURAL MEMBERS AND ROOF JOISTS. DO NOT SUPPORT CONDUITS FROM CEILING THE WIRES, DUCTWORK, PIPING OR OTHER NONSTRUCTURAL MEMBERS.
12. A) INDEPENDENTLY AND SECURELY MOUNT WALL AND CEILING FIXTURES SO THAT THEY ARE NOT DEPENDENT ON CEILING FINISH FOR SUPPORT AND CANNOT BE ROTATED OR DISPLACED.
B) FIXTURES AND DEVICES MOUNTED IN SUSPENDED ACOUSTICAL TILE SHALL HAVE CHANNEL SUPPORTS ACROSS THE MAIN GRID RUNNERS OR GRID SUPPORTS, SECURELY TIED DOWN OR ANCHORED SO AS NOT TO CAUSE TIE TO SAG AND SO THAT FIXTURE OR DEVICE CANNOT BE LIFTED, ROTATED OR DISPLACED. MINIMUM SUPPORTS SHALL INCLUDE 2 CHAINS AT DIAGONALLY OPPOSITE CORNERS.
C) PROVIDE AND INSTALL GRID TROFFER SUPPORT CLIPS.
13. PANELBOARDS: COPPER BUS
A) PROVIDE BREAKERS BOLTED IN PLACE. BREAKERS TO HAVE MINIMUM 10,000 AC RATING. MULTI-POLE BREAKERS WITH COMMON TRIP SHALL BE FURNISHED WITH 4 BREAKER LOCK-ONE FOR EACH BRANCH CIRCUIT PANELBOARD.
B) BALANCE PANEL FEEDERS WITHIN 5% UNDER FULL LOAD CONDITIONS.
C) VERIFY ELECTRICAL REQUIREMENTS FOR MOTORS AND EQUIPMENT PRIOR TO ORDERING BREAKERS FOR PANELBOARDS.
D) PROPERLY FILL IN CIRCUIT DIRECTIONS WITH A TYPEWRITER AT THE COMPLETION OF THE JOB, WITH DESIGNATIONS AS DETERMINED BY ARCHITECT.
14. LOW VOLTAGE DRY TYPE DISTRIBUTION TRANSFORMERS SHALL MEET THE CLASS 1 EFFICIENCY LEVELS FOR LOW VOLTAGE DISTRIBUTION TRANSFORMERS SPECIFIED IN TABLE 4-2 OF THE GUIDE FOR DETERMINING ENERGY EFFICIENCY FOR DISTRIBUTION TRANSFORMERS, PUBLISHED BY THE NATIONAL ELECTRICAL MANUFACTURERS ASSOCIATION (NEMA STANDARD TP-1-2002), IN EFFECT ON THE EFFECTIVE DATE OF THIS ARTICLE.
15. MOUNT OUTLET BOXES FLUSH AND CONCEAL CONDUIT UNO ROUTING AND METHODS USED TO ACHIEVE CONCEALMENT AND FLUSH EQUIPMENT INSTALLATION ARE THE RESPONSIBILITY OF THE CONTRACTOR. COORDINATE WITH OTHER AFFECTED TRADES. SEE SPECIFICATIONS FOR CUTTING AND PATCHING.
16. REMODELING, MODIFYING, PATCHING AND REPAIR OF EXISTING BUILDING COMPONENTS SHALL BE DONE AS REQUIRED TO PRODUCE FINISHED WORK EQUAL TO THE NEW WORK AS SPECIFIED AND DETAILED CUTTING AND PATCHING SHALL BE THE RESPONSIBILITY OF THE TRADE WIDSE WORK RESULTS IN THE NEED FOR CUTTING AND PATCHING, UNLESS A SPECIFIED CONTRACTOR IS CALLED OUT ON THE DRAWINGS. COMPLETE WORK NECESSARY TO ACHIEVE THIS REQUIREMENT, EVEN THOUGH PROCEDURES ARE NOT DETAILED AND/OR SPECIFIED FOR EACH SPECIFIC CONDITION OR COMBINATION OF CONDITIONS. QUALITY OF WORKMANSHIP, MATERIALS AND FINISH SHALL BE EQUAL TO THE LEVEL ESTABLISHED FOR SIMILAR NEW WORK, EXCEPT WHERE EXISTING APPEARANCE IS TO BE MATCHED TO PROVIDE CONTINUITY.
17. DEFINITIONS: FURNISH - OBTAIN, PAY FOR AND DELIVER TO THE WORK SITE. INSTALL - TRANSPORT, CONNECT, TEST AND PLACE IN OPERATION. PROVIDE - FURNISH AND INSTALL. INDICATED - PORTRAYED BY PRINTED OR GRAPHIC MEANS.
18. PROVIDE PULL STRING IN ALL SPARE/EMPTY CONDUITS (TYPICAL).

ELECTRICAL NOTES

- A. THE SCOPE OF THE WORK COVERED BY THESE SPECIFICATIONS INCLUDES LABOR, EQUIPMENT, AND MATERIALS FOR THE COMPLETE ELECTRICAL SYSTEM. MATERIALS AND EQUIPMENT ARE NEW, OF MANUFACTURER'S STANDARD CONSTRUCTION, INSTALLED IN ACCORDANCE WITH ACCEPTED PRACTICE. RESPONSIBILITY CONTINUES FOR CORRECTION OF DEFECTIVE MATERIAL AND WORK DISCLOSED DURING THE GUARANTEE PERIOD OR THE FIRST OPERATING SEASON. THE DRAWINGS AND SPECIFICATIONS ARE COOPERATIVE AND SUPPLEMENTARY, AND IT IS THE INTENT OF BOTH DRAWINGS AND SPECIFICATIONS TO COVER THE ELECTRICAL REQUIREMENTS AS NEARLY AS POSSIBLE. CLOSELY CHECK THE DRAWINGS AND SPECIFICATIONS FOR ANY OBVIOUS CONFLICTS, ERRORS OR OMISSION AND NOTIFY THE ENGINEER OF ANY PRIORITY TO THE RECEIPT OF BIDS. PROPERLY ADJUST THE VARIOUS ELECTRICAL DEVICES, BALANCE PHASES, MAKE THE REQUIRED TESTS, ETC., UNTIL THE ENTIRE ELECTRICAL INSTALLATION FUNCTIONS PROPERLY IN EVERY DETAIL.
B. RACEWAYS - PROVIDE CONDUIT OF TYPES AND SIZES INDICATED WITH FITTINGS AND ACCESSORIES FOR A COMPLETE SYSTEM. USE 3/4" TRADE SIZE MIN. AND SECURITY SUPPORT USING BOLTED CLAMP TYPE HANGERS, LIKE MINERALLAC OR CHANNEL TYPE LIKE B-LINE. GALVANIZED RIGID STEEL CONDUIT - FOR: PANEL FEEDERS, WET LOCATIONS, WHERE SUBJECT TO ABUSE, WHERE 2-1/2" TRADE SIZE OR LARGER IS INDICATED.
C. ELECTRICAL METALLIC TUBING (EMT) - FOR PROTECTED, DRY LOCATIONS, BRANCH CIRCUITS AND COMMUNICATION RACEWAY UP TO 2" TRADE SIZE. USE STEEL BODY COMPRESSION TYPE COUPLINGS AND CONNECTORS (SET-SCREW AND DIE CAST ARE NOT ACCEPTABLE) - NON-METALLIC CONDUIT (SCHEDULE 40 PVC) - BELOW GRADE, EXTERIOR OF BUILDING ONLY.
D. WIRE AND CABLE - PROVIDE COPPER CONDUCTOR OF INDICATED TYPE/SIZE. RUN ALL WIRE IN CONDUIT, UNO USE 2 #12, #12 GRD. MIN. MC CABLE MAY BE USED WHEN IN COMPLIANCE WITH NEC. TYPE THHN/THWN FOR #6 AWG AND SMALLER EXCEPT FOR WIRE BELOW GRADE. TYPE XHHW FOR LARGER THAN #6 AWG AND FOR ALL WIRE BELOW GRADE.
E. BOXES AND FITTINGS - PROVIDE BOXES AND FITTINGS OF APPROPRIATE TYPE FOR EACH APPLICATION: USE: APPLETON, 0.2/GEENEY, HUBBELL. EXTERIOR (WEATHERPROOF) BOXES - CAST METAL, CORROSION RESISTANT, THREADED CONDUIT ENTRY, WITH MATING COVERS AND GASKETS. FOR EXTERIOR USE HUBBELL #5221 FIBERGLASS/PLASTIC COVER FOR DUPLEX RECEPTACLE. INTERIOR BOXES SHALL BE 4" MIN. SQUARE FITTED WITH SQUARE CUT DEVICE RING OR SINGLE PIECE MASONRY TYPE, NON-GANGABLE AND SET FLUSH WITH FINISHED SURFACE. JUNCTION AND PULL BOXES - PROVIDE CODE-GAGE, GALVANIZED STEEL APPROPRIATE FOR EACH APPLICATION. CONSTRUCT WITH WELDED SEAMS AND SCREW COVERS ATTACHED WITH STAINLESS STEEL FASTENERS.
F. WIRING DEVICES - PROVIDE WHERE INDICATED WHITE WIRING DEVICES OF CONFIGURATION RATING AND TYPE. USE: G.E., LEVITON OR HUBBELL. DUPLEX RECEPTACLE - UL LISTED AS FED SPEC COMPLIANT, 20-AMP, 125V, 3-WIRE, 2-HOLE WITH GROUNDED TERMINALS. RATED FOR LOADS, LOADS, SCREW ACTIVATED PRESSURE PLATE TERMINALS. BACK AND SIDE WIRED WITH GROUND TERMINAL BONDED TO MOUNTING YOKE. MOUNT WITH GROUND TERMINAL UP.
G. GROUND FAULT CIRCUIT INTERRUPTER (GFCI) - 20 AMP GFI, 120 VOLT, SOLID STATE, 5 MILLISEC TRIP LEVEL, HUBBELL #6F5262 OR EQUAL.
H. MOTOR AND CIRCUIT DISCONNECTS - PROVIDE PROPER HP, VOLTAGE AND CURRENT RATING & NEMA TYPE DISCONNECT. FURNISH WITH OVERCURRENT PROTECTION AND OTHER ACCESSORIES AS ENCLOSED. USE NEMA 3R ENCLOSURE IN WET LOCATIONS. USE: SQUARE D OR G.E.. SWITCH TYPE - HEAVY DUTY, SHEET STEEL ENCLOSED, 2, 3 OR 4 POLE, QUICK-BREAK, VISIBLE BLADE, INTERLOCKED DOOR, PAD LOCK LOCKOUT PROVISION HIGH CONDUCTIVITY COPPER CURRENT CARRYING PARTS, SILVER TUNGSTEN CONTACTS, POSITIVE PRESSURE/SRING ASSISTED FUSE CLIPS (FUSED TYPES).
I. FUSES - PROVIDE PROPER SELECTION OF FUSE(S) FOR EACH APPLICATION INDICATED AND WITH RESPECT TO VOLTAGE, CURRENT LIMIT, TIME/CURRENT CHARACTERISTICS, AND AVAILABLE FAULT CURRENT. FURNISH PRODUCTS OF ONE OF THE FOLLOWING BUSSMAN, GOLDT OR LITFUSE. UL CLASS RK1 - 250 OR 600 VOLT RATING, 0-600 AMPERES. USE FOR PROTECTION OF CIRCUIT BREAKER PANELBOARDS.
J. INSTALLATION - INSTALL COMPLETE RACEWAY SYSTEM IN PROGRESS WITH OTHER TRADES AND PRIOR TO PULLING WIRE/CABLE. FOLLOW NECA GUIDELINES FOR NEAT, FIRST CLASS WORKMANSHIP. SELECT PROPER SUPPORTS AND ANCHORS AND ALLOW AIR SPACE WHEN MOUNTING TO MASONRY OR CONCRETE SURFACES. WIRE LANDED ON BACK-WIRED DEVICES AND CLAMP TYPE TERMINAL BLOCKS DO NOT REQUIRE CRIMPED Wires. MOUNT WITH TOP AT 66". SELECT FUSES BASED ON NAME PLATE RATING OR OTHER MANUFACTURER'S RECOMMENDATION WHEN AVAILABLE AND INSTALL IN EACH FUSIBLE DEVICE. PLACE INTUMESCENT FILL MATERIAL IN PENETRATIONS OF FIRE RATED ASSEMBLIES. MARK PANELBOARDS WITH ACRYLIC ENGRAVED NAMEPLATES. PANEL DESIGNATION ABOVE DOOR AND INSIDE OF DOOR WITH PANEL DESIGNATION, VOLTAGE AND FEEDER DESIGNATION. MARK STARTERS, DISCONNECTS, ETC. WITH UNIT DESIGNATION, EQUIPMENT SERVED, VOLTAGE AND FEED CIRCUIT. APPLY FOLLOWING FINISH PAINTING AS APPLICABLE. BLUNT SCREW POINTS AFTER INSTALLATION TO PREVENT INJURY.
K. GROUND THE ELECTRICAL SYSTEM. PROVIDE WIRE, CABLE, LUGS, CLAMPS, SURGE ARRESTORS AND RELATED PRODUCTS AS REQUIRED FOR A COMPLETE GROUNDING SYSTEM. PROVIDE EQUIPMENTS GROUNDING CONDUCTOR IN ALL CONDUITS. SIZE WIRE ACCORDING TO THE NEC.

SYMBOL LEGEND - LIGHTING

Table with 2 columns: SYMBOL and DESCRIPTION. Symbols include icons for exit light, surface or recessed light fixture, light fixture, EM type, light fixture, undercabinet light, K (light fixture), and o (lower case letter).

SYMBOL LEGEND - LIGHTING CONTROLS

Table with 2 columns: SYMBOL and DESCRIPTION. Symbols include icons for timeclock, ceiling mount occupancy sensor, single pole switch, three-way switch, and dual technology occupancy sensing dimmer.

SYMBOL LEGEND - SYSTEMS

Table with 2 columns: SYMBOL and DESCRIPTION. Symbols include icons for fire pull station, audio/visual signal, visual fire alarm signal, ceiling mount audio visual device, tamper switch, flow switch, and fire alarm control panel.

ABBREVIATIONS

Table with 4 columns: MARK, DEFINITION, MARK, DEFINITION. Lists abbreviations for materials like AMPERES, ABOVE FINISHED FLOOR, AMP INTERRUPT CAPACITY, ALUMINUM, AUDIO VISUAL BUILDING BREAKER, etc.

SYMBOL LEGEND - POWER

Table with 2 columns: SYMBOL and DESCRIPTION. Symbols include icons for wall mounted duplex receptacle, special purpose receptacle, television system outlet, emergency power off push button, junction box, wall mounted tele/data outlet, thermostat, data/telephone terminal board, panel board, and transformer.

GENERAL NOTES

- 1. VERIFY DIMENSIONS FROM ARCHITECTURAL DRAWINGS.
2. INSTALL FIXTURES ON ACOUSTICAL TILE MODULES UNLESS OTHERWISE INDICATED.
3. OUTLET DIMENSIONS ARE TO BOTTOM OF BOX.
4. CIRCUITING INDICATED IS TO SHOW SWITCHING ETC. NOT QUANTITY OR EXACT LOCATION.
5. VERIFY EXACT LIGHT FIXTURE LOCATION IN COORDINATION WITH OTHER TRADES AND RELOCATE AS NECESSARY FOR EXPOSED DUCTS, PIPING, ETC. AS DIRECTED.
6. PROVIDE SILK SCREEN PRINTED CIRCUIT LABELS FOR ALL RECEPTACLES AND DATA OUTLETS. PROVIDE ENGRAVED ACRYLIC NAMEPLATES FOR ALL PANELBOARDS AND DISCONNECTS. DISCONNECTED NAMEPLATE SHALL INCLUDE NAME OF UNIT AS WELL AS CIRCUIT FEEDING UNIT. LOCATE DATA OUTLETS NO MORE THAN 2" FROM CORRESPONDING RECEPTACLE.
7. VERIFY FURNITURE, EQUIPMENT, ETC., MOUNTED OUTLET LOCATIONS WITH EQUIPMENT SUPPLIER PRIOR TO ROUGH-IN.
8. COMPLY WITH NEC 408.4(A). CLEARLY IDENTIFY CIRCUITS ON PANEL DIRECTORIES TO INCLUDE LOCATION SERVED AS WELL AS ITEM (I.E. REC - HALL 102)

REMODEL NOTES

- 1. REMOVE ELECTRICAL WORK FROM WALLS, CEILING, AND OTHER SURFACES TO BE REMOVED.
2. REMOVE ABANDONED CONDUCTOR, ELECTRICAL EQUIPMENT, AND ACCESSIBLE RACEWAY.
3. BLANK OFF ABANDONED OUTLETS USING PLATE TO MATCH DEVICE COVERS OR PATCH OPENINGS AND FINISH TO MATCH ADJACENT SURFACE.
4. EXISTING EQUIPMENT DEVICES, ETC. INDICATED TO REMAIN ARE INTENDED TO REMAIN OPERATIONAL. RECIRCUIT OR REROUTE CIRCUITS AS REQUIRED TO MAINTAIN OPERATION.
5. REMOVE EXISTING LIGHT FIXTURES FROM AREAS WHERE NEW LIGHTING IS INDICATED.
6. EXISTING WORK INDICATED IS INTENDED TO BE A REASONABLE APPROXIMATION AND IS FOR CONVENIENCE ONLY, NOT FOR THE BASIS OF BIDDING. DETERMINE EXACT QUANTITIES AND LOCATIONS AT THE JOB SITE.
7. PROVIDE NEW TYPED CIRCUIT DIRECTORIES FOR PANELS WITH CIRCUIT CHANGES OR ADDITIONS.

Logo for EDA (Electrical Design Associates) with contact information: 7838 N. La Cholla Blvd., Tucson, Arizona 85711, Phone (520) 625-2100, Fax (520) 625-2108, www.eda-az.com, Project #: 22078

Vertical strip on the right side containing logos for MSMA ARCHITECTS, KATFALL 2002-2024 MECH/ELECTRICALS, and ELECTRICAL SYMBOLS, NOTES AND ABBREVIATIONS E0.0



1 ELECTRICAL DEMOLITION PLAN
1/8" = 1'-0" NORTH

GENERAL NOTES:

A. DEVICES NOT SHOWN ARE EXISTING TO REMAIN, UNO.

KEY NOTES:

1. REMOVE (E) LIGHTS & SWITCHES. REMOVE EXISTING CEILING MOUNTED DEVICES. MAINTAIN ASSOCIATED CONDUIT AND CONDUCTORS TO POWER REPLACED LIGHTS THIS AREA.
2. REMOVE (E) WALL MOUNT DEVICES AND ASSOCIATED CONDUIT AND CONDUCTORS FOR WALLS TO BE REMOVED THIS AREA.
3. REMOVE EXISTING WALL MOUNT DATA SWITCH/PATCH PANELS AND SALVAGE TO OWNER.
4. REMOVE EXISTING FLOOR MOUNT DATA SWITCH/PATCH PANELS AND SALVAGE TO OWNER.
5. REMOVE WIREMOLD AND ASSOCIATED CONDUITS & CONDUCTORS THIS AREA.
6. REMOVE START/STOP MASTER COMPUTER SWITCH AND ASSOCIATED CONTACTORS.
7. REMOVE EXISTING CEILING PROJECTOR, CAMERAS AND SPEAKERS. SALVAGE TO OWNER.
8. REMOVE CAMERA THIS AREA. SALVAGE TO OWNER.

REMOVE POWER TO DOOR OPERATOR. REMOVE ASSOCIATED PUSH BUTTON.

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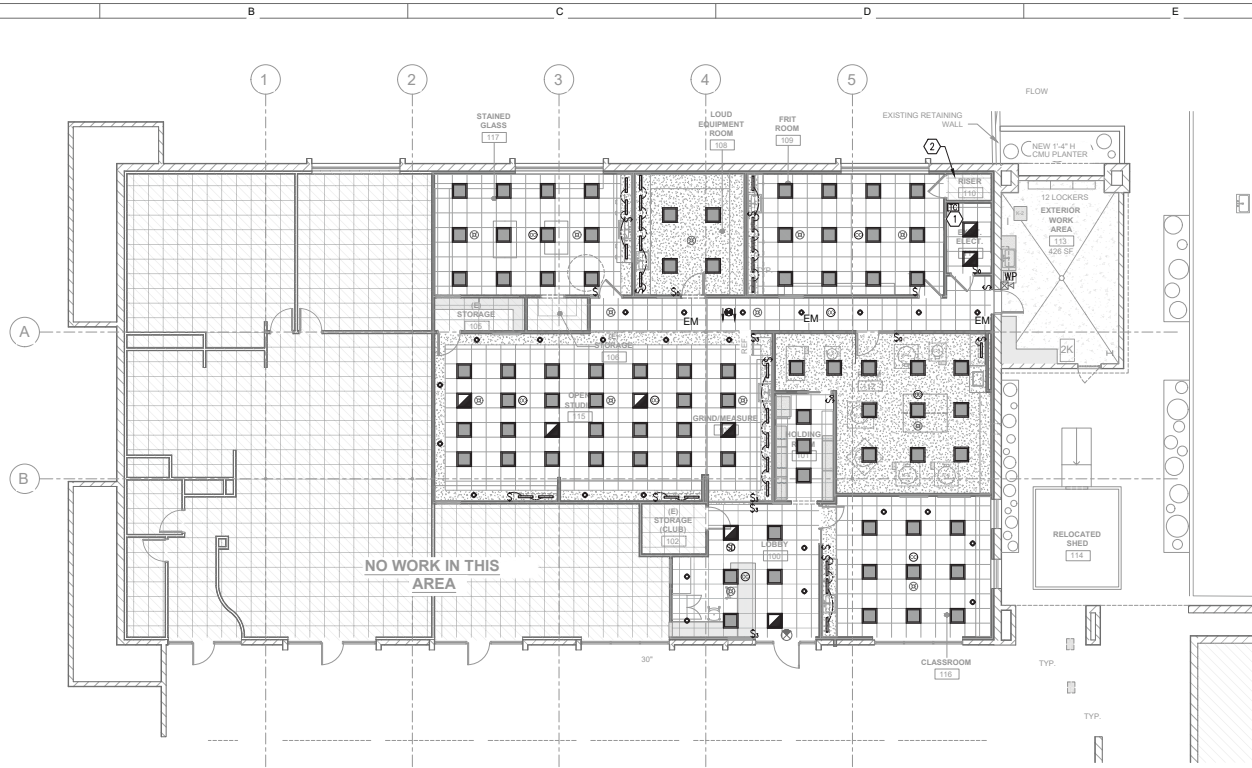
SEAL
REGISTERED PROFESSIONAL ARCHITECT
STATE OF ARIZONA
13746 SARAH JEWETT LESDA
LICENSE NO. 21720
Sarah J. Lesda

Glass Arts Ti at Santa Rita Springs
Green Valley Recreation
921 W Via Rio Fierro, Green Valley, AZ 85614

2023-01-24 MECH REVISIONS	▲
DRAWN BY	KATJAU
APPROVED BY	SJK
ISSUED FOR	
ISSUE DATE	12/02/2022
PROJECT NUMBER	217203030
FIELD BOOK	

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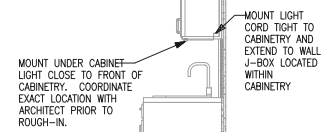
ELECTRICAL DEMOLITION PLAN
ED1.0



CEILING LIGHTS THIS VIEW CIRCUIT A1HA-1
 UNDERCABINET LIGHTS THIS VIEW CIRCUIT A1LA-15

1 LIGHTING PLAN
 1/8" = 1'-0" NORTH

2 UNDERCABINET LIGHT DIAGRAM
 NO SCALE



GENERAL NOTES:

- A. LIGHT FIXTURE TYPE MARKINGS, UNO:
 K1 - 2x2 LIGHTS, ACT CEILING
 K2 - 2x2 LIGHTS, DRYWALL CEILING
 K3 - DOWNLIGHTS
 K4 - UNDERCABINET LIGHTS
- B. CIRCUIT EM AND EXIT SIGNS TO NEAREST LIGHTING CIRCUIT. CONNECT AHEAD OF SWITCHING IN COMPLIANCE WITH NEC 700.12 (F).
- C. MANUFACTURER OF SUBMITTED/APPROVED CEILING AND WALL MOUNTED OCCUPANCY SENSORS TO VERIFY PLACEMENT FOR PROPER COVERAGE AND FUNCTIONALITY OF DEVICES.
- D. LOCATE WALL SWITCHES SUCH THAT EDGE OF COVERPLATE IS 4" MAX FROM ADJACENT DOOR JAMB.
- E. EXTERIOR LIGHTS EXISTING TO REMAIN.

KEY NOTES:

- 1. PROVIDE LIGHTING CONTROL PANEL THIS AREA.
- 2. EXISTING LIGHTS TO REMAIN. NO WORK.

COMcheck Software Version 4.1.5.5
Interior Lighting Compliance Certificate

Project Information

Energy Code: 2018 IECC
 Project Title: Alteration
 Project Type:

Construction Site: _____ Owner/Agent: _____ Designer/Contractor: _____

A	B	C	D
Area Category	Floor Area (ft ²)	Allowed Watts / ft ²	Allowed Watts (B X C)
1 School/University	4967	0.81	4023
		Total Allowed Watts =	4023

A	B	C	D	E
Fixture ID : Description / Lamp / Wattage Per Lamp / Ballast	Lamps / Fixture	# of Fixtures	Fixture Watt.	(C X D)
School/University (4967 sq.ft.)				
LED 1: K1; Other:	1	72	19	1368
LED 2: K2; Other:	1	15	30	450
LED 3: K3; Other:	1	25	18	450
LED 4: K4; Other:	1	26	12	260
		Total Proposed Watts =		3528

Interior Lighting PASSES

MARK	MANUFACTURER'S CATALOG #	MOUNT	LED LAMPING	LUMENS	VOLTAGE	SIZE	COLOR OR FINISH	DIMMING	LENS & DISTRIBUTION	OPTIONS & REMARKS
K1	LITHONIA #EPANL SERIES COLUMBIA #CFP SERIES	RECESS	19W	2000	MVOLT	24" x 24" x 2"	WHITE	10% 0-10V	SATIN WHITE	
K2	LITHONIA #EPANL SERIES COLUMBIA #CFP SERIES	RECESS	30W	3400	MVOLT	24" x 24" x 2"	WHITE	10% 0-10V	SATIN WHITE	DRYWALL INSTALL KIT
K3	LITHONIA #LDNG/L06 SERIES PRECOLITE #LIR-6RD SERIES	RECESS	18W	1500	MVOLT	6"Øx7" x 6"	MATTE DIFFUSE	10% 0-10V	WHITE	
K4	LITHONIA #UCLD SERIES	UNDER CABINET	10W	585	120V	4"x1" x 18"	WHITE	1%	ACRYLIC	NO ROCKER SWITCH; HARD WIRE
EXIT	LITHONIA #EDG SERIES DUAL LITE #EVE SERIES	WALL	GREEN LED		MVOLT	13"x5" x 12"	BRUSHED ALUMINUM		EDGE LIT ACRYLIC	NI-CAD BATTERY; FULL 5-YR. WARRANTY; 3-YRS PRO-RATA @ 33% / YR.

- NOTES:**
1. PROVIDE 90 CRI FOR ALL FIXTURES; NO LESS THAN 80 CRI IF 90 IS NOT AVAILABLE.
 2. PROVIDE 3500K FOR ALL INTERIOR LIGHTING, UNO.
 3. EQUALS IN QUALITY, PERFORMANCE, AND AESTHETICS BY ACUTY, COOPER/EATON, HUBBELL, AND PHILIPS ARE ACCEPTABLE.
 4. PROVIDE INTEGRAL EMERGENCY BATTERY BACKUP WITH 1000 LUMENS FOR FIXTURE SYMBOLS SHOWN AS EMERGENCY.
 5. STANDARD MANUFACTURERS 5 YEAR WARRANTY, UNO.
 6. LIGHT FIXTURE NAMEPLATE WATTAGE SHALL NOT EXCEED LED LAMP WATTAGES INDICATED.
 7. VERIFY DIMMER COMPATIBILITY PER LIGHT FIXTURE TYPE MARKING PRIOR TO ORDERING.
 8. FIXTURE MOUNTING HEIGHT SHOWN IS TO BOTTOM OF FIXTURE, UNO.

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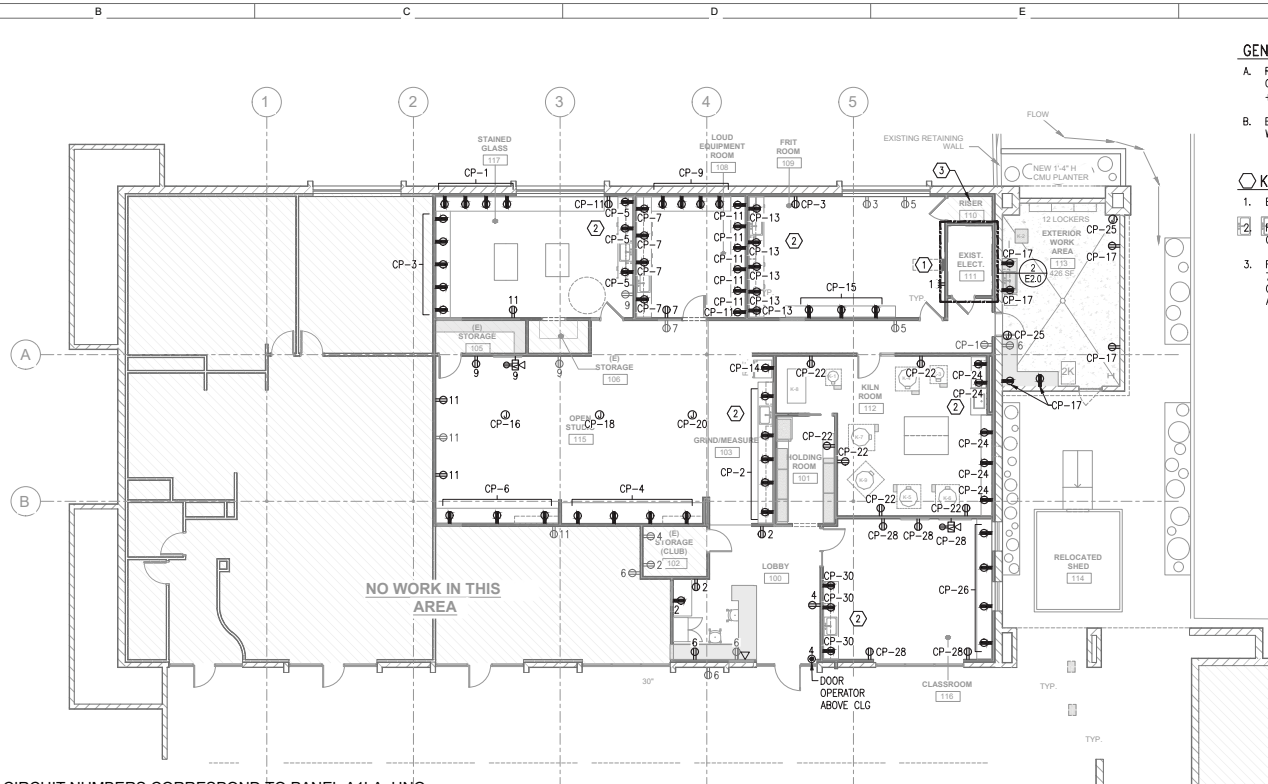


Glass Arts Tl at Santa Rita Springs
 Green Valley, AZ 85614

2023-01-24	MEDH REVISIONS
DRAWN BY	KATAJU
APPROVED BY	S.L.
ISSUED FOR	
ISSUE DATE	12/02/2022
PROJECT NUMBER	217203103
FIELD BOOK	

**LIGHTING PLAN,
 LIGHT FIXTURE
 SCHEDULE &
 CALC**


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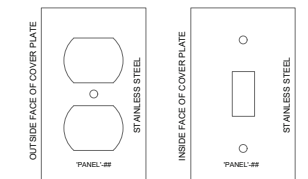
- GENERAL NOTES:**
- RECEPTACLES WITHIN 6' OF SOURCES OF WATER, PROVIDE GFCI DEVICE, +42" AFF.
 - EXTERIOR RECEPTACLES SHALL BE GFCI, WP WITH PLUG INSERTED.
- KEY NOTES:**
- ETR PANEL(S).
 - RECEPTACLES THIS AREA +42" AFF, GFCI.
 - REPLACE EXISTING TRANSFORMER WITH 75KVA. VERIFY CLEARANCES PRIOR TO ORDERING. PROVIDE WITH FEET TO SIT ABOVE THE FLOOR.

CIRCUIT NUMBERS CORRESPOND TO PANEL A1LA, UNO.

1 POWER PLAN
1/8" = 1'-0"



2 ENLARGED PLAN
1/4" = 1'-0"

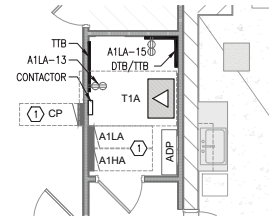

3 COVER PLATE LABEL DIAGRAM
NO SCALE

ART EQUIPMENT FEEDER SCHEDULE

ITEM #	DESCRIPTION	DEVICE	CIRCUIT	CONDUIT / WIRE	NOTES
K-1	KILN - AIM	NEMA 5-20	CP-27	3/4" C, 2#10, #10 GRD.	1,2,3,4
K-2	KILN - AIM VITRIGRAPH	NEMA 5-20	CP-29	3/4" C, 2#12, #12 GRD.	1,2,3,4
K-3	KILN - JEN-KEN	NEMA 5-20	CP-31	3/4" C, 2#10, #10 GRD.	1,2,3,4
K-4	KILN - PARAGON	NEMA 6-50	A1LA-17,19	1" C, 2#6, #10 GRD.	1,2,3,4
K-5	KILN - SKUTT 1014	NEMA 6-50	A1LA-23,25	1" C, 2#8, #10 GRD.	1,2,3,4
K-6	KILN - SKUTT 1027A	NEMA 6-50	A1LA-16,18	1" C, 2#6, #10 GRD.	1,2,3,4
K-7	KILN - SKUTT 1027B	NEMA 6-50	A1LA-20,22	1-1/4" C, 2#4, #8 GRD.	1,2,3,4
K-8	KILN - GTS 41	NEMA 6-50	CP-39,41	1-1/4" C, 2#4, #8 GRD.	1,2,3,4,5
K-9	KILN - SP 28	NEMA 6-50	CP-38,40	1" C, 2#6, #10 GRD.	1,2,3,4,5
ZJ	CA TOOLS AIR COMP #CAT-4620-AC		CP-33	3/4" C, 2#10, #10 GRD.	1,2,3,4
ZK	HOMAK VERT BLASING #R000924380		CP-35	3/4" C, 2#12, #12 GRD.	1,2,3,4

- NOTES:**
- PROVIDE DISCONNECT: NEMA 1 FOR INTERIOR DRY LOCATIONS
NEMA 3R FOR EXTERIOR OR WET LOCATIONS
 - FUSE FOR MOTOR OVERLOAD PROTECTION BASED ON NAMEPLATE DATA
 - PROVIDE 120V OR 208V RECEPTACLE AMPERAGE AS REQUIRED OR J-BOX AS REQUIRED
 - COORDINATE CORD/PLUG CONNECTION WITH OWNER PROVIDED EQUIPMENT PRIOR TO ROUGH-IN.
PROVIDE CORRESPONDING DEVICE AS REQUIRED.
 - DO NOT OPERATED KILNS K-8 AND K-9 SIMULTANEOUSLY

ONE LINE DIAGRAM FEEDER SCHEDULE

ITEM	ETR / PROVIDE	CU FEEDER	GRD ELECTRODE	NOTES
200A PANEL	PROVIDE	2-1/2" C, 4 #4/0, #4 GRD.		PANEL A1LA
75 KVA XFMR	PROVIDE	2" C, 3 #1, #6 GRD.	#4	PRIMARY FEEDER XFMR T1A
	PROVIDE	2-1/2" C, 4 #4/0, #4 GRD.		SECONDARY FEEDER XFMR T1A

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MSM ARCHITECTS
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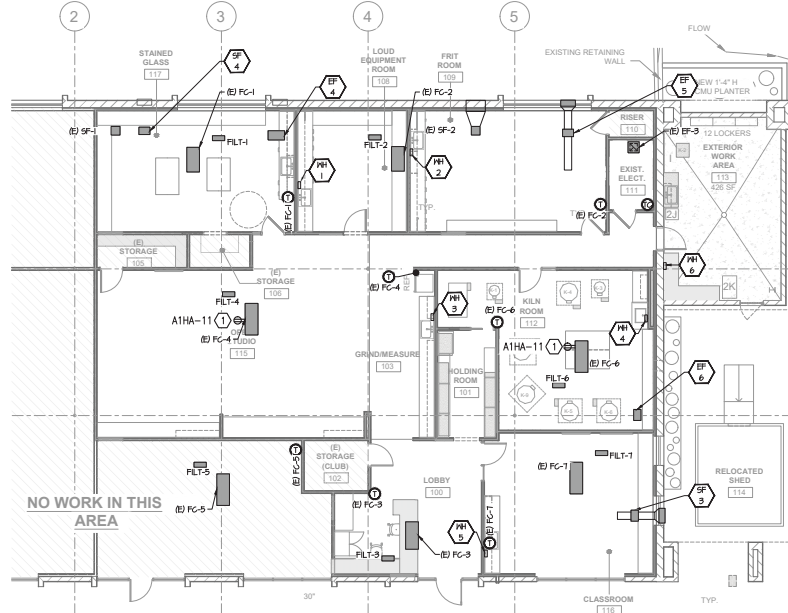
Glass Arts T1 at Santa Rita Springs

2023.01.24 MECH REVISIONS

DRAWN BY: KATALLI S.L.
APPROVED BY: S.L.
ISSUED FOR: 12022022
PROJECT NUMBER: 217203103
FIELD BOOK

POWER PLAN, EQUIPMENT & ONE LINE SCHEDULE

E2.0



1 MECHANICAL POWER PLAN
1/8" = 1'-0"



KEY NOTES:

- GFCI, WP WITH PLUG INSERTED, ON ROOF.

ELECTRICAL FEEDER SCHEDULE - MECHANICAL EQP

TAG	ETR	CIRCUIT	FEEDER	DISCONNECT SIZE	NOTES
EF-4		A1LA-12	3/4" C, 2#12, #12 GRD.	30A	4,5,6
EF-5		A1LA-12	3/4" C, 2#12, #12 GRD.	30A	4,5,6
EF-6		A1LA-12	3/4" C, 2#12, #12 GRD.	30A	4,5,6
SF-3		A1LA-10	3/4" C, 2#12, #12 GRD.	30A	4,5,6
SF-4		A1LA-10	3/4" C, 2#12, #12 GRD.	30A	4,5,6
FILT-1		A1LA-24	3/4" C, 2#12, #12 GRD.	30A	4,6,8
FILT-2		A1LA-24	3/4" C, 2#12, #12 GRD.	30A	4,6,8
FILT-3		A1LA-24	3/4" C, 2#12, #12 GRD.	30A	4,6,8
FILT-4		A1LA-24	3/4" C, 2#12, #12 GRD.	30A	4,6,8
FILT-5		A1LA-26	3/4" C, 2#12, #12 GRD.	30A	4,6,8
FILT-6		A1LA-26	3/4" C, 2#12, #12 GRD.	30A	4,6,8
FILT-7		A1LA-26	3/4" C, 2#12, #12 GRD.	30A	4,6,8
FC-1	X	A1LA-31,33	3/4" C, 2#12, #12 GRD.	30A	1,2,3
FC-2	X	A1LA-31,33	3/4" C, 2#12, #12 GRD.	30A	1,2,3
FC-3	X	A1LA-35,37	3/4" C, 2#12, #12 GRD.	30A	1,2,3
FC-4	X	A1LA-39,41	3/4" C, 2#12, #12 GRD.	30A	1,2,3
FC-5	X	A1LA-39,41	3/4" C, 2#12, #12 GRD.	30A	1,2,3
FC-6	X	A1LA-35,37	3/4" C, 2#12, #12 GRD.	30A	1,2,3
FC-7	X	A1LA-35,37	3/4" C, 2#12, #12 GRD.	30A	1,2,3
CU-1	X	ETR	1" C, 3#8, #10 GRD.	60A	1,2,3
CU-2	X	F1HA-19,21,23	1" C, 3#8, #10 GRD.	60A	1,2,3
CU-3	X	F1HA-19,21,23	1" C, 3#8, #10 GRD.	60A	1,2,3
CU-4	X	F1HA-19,21,23	1" C, 3#8, #10 GRD.	60A	1,2,3
CU-5	X	F1HA-19,21,23	1" C, 3#8, #10 GRD.	60A	1,2,3
CU-6	X	ETR	1" C, 3#8, #10 GRD.	60A	1,2,3
CU-7	X	ETR	1" C, 3#8, #10 GRD.	60A	1,2,3
WH-1		A1HA-18	1" C, 2#8, #10 GRD.	60A	1,6,7
WH-2		A1HA-7	3/4" C, 2#12, #12 GRD.	30A	1,6,7
WH-3		A1HA-9	3/4" C, 2#12, #12 GRD.	30A	1,6,7
WH-4		A1HA-8	3/4" C, 2#12, #12 GRD.	30A	1,6,7
WH-5		A1HA-10	3/4" C, 2#12, #12 GRD.	30A	1,6,7
WH-6		A1HA-12	3/4" C, 2#12, #12 GRD.	30A	1,6,7

NOTES:

- PROVIDE DISCONNECT: NEMA 1 FOR INTERIOR DRY LOCATIONS
NEMA 3R FOR EXTERIOR OR WET LOCATIONS
LOCATE ON UNISTRUT ADJACENT TO UNIT
- FUSE FOR MOTOR OVERLOAD PROTECTION BASED ON NAMEPLATE DATA
- 100K MAX AVAILABLE FAULT CURRENT; SCRR RATING TO INCLUDE ALL COMPONENTS,
NO ADDITIONAL UPSTREAM PROTECTION
- PROVIDE MOTOR-RATED SWITCH
- PROVIDE 365-DAY TIMER, FAN TO RUN DURING OCCUPIED HOURS
- PROVIDE 120V, 20A GFCI RECEPTACLE OR J-BOX AS REQUIRED
- COORDINATE CORD/PLUG CONNECTION REQUIREMENTS WITH EQUIPMENT
SUPPLIER PRIOR TO ROUGH-IN.
- INTERLOCK FILT-# WITH ASSOCIATED FC SUPPLY FAN FOR SIMULTANEOUS OPERATION.

7836 N. La Cholla Blvd.
Phoenix, Arizona 85024
Phone (602) 855-2106
Fax (602) 855-2108
www.eda-as.com
Project #: 22078

MSM ARCHITECTS
DIVISION OF SHIVE-HATTERY

SEAL
SARAH JEWETT
LESA
REGISTERED ELECTRICAL ENGINEER
STATE OF ARIZONA
LICENSE NO. 19379
SARAH JEWETT
LESA


Glass Arts Ti at Santa Rita Springs
Green Valley, Pheasanton
921 W. Via Rio Events, Green Valley, AZ 85614

2023-01-24 MECH/REVISIONS

DATE	BY	REVISION
21/2/2019 <td>KATAJU <td>SL </td></td>	KATAJU <td>SL </td>	SL
12/02/2022 <td></td> <td></td>		
21/2/2019 <td></td> <td></td>		

DRAWN BY: KATAJU
APPROVED BY: SL
ISSUED FOR: 12/02/2022
PROJECT NUMBER: 21/2/2019
FIELD BOOK

ENLARGE KILN ROOM & MECHANICAL POWER PLAN
E2.1

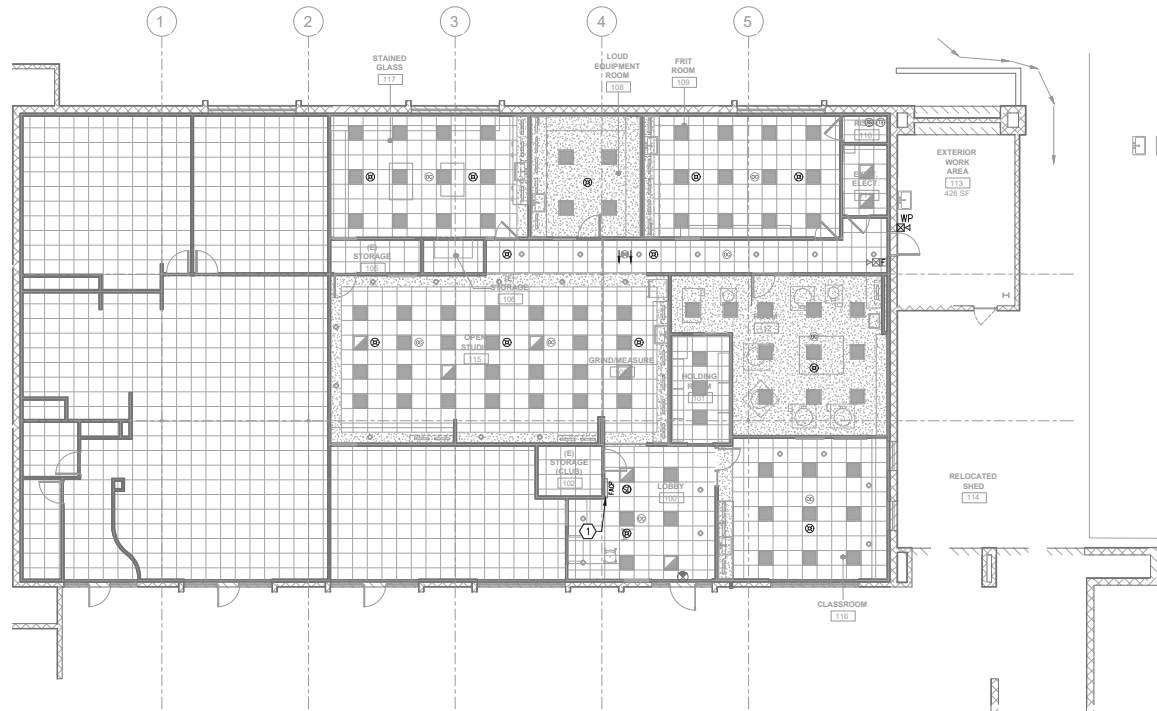

1 SYSTEMS PLAN
1/8" = 1'-0"

FIRE ALARM GENERAL NOTES:

- A. COMPLY WITH IFC 2018, 510.1 EMERGENCY RESPONDER RADIO COVERAGE. NEW BUILDINGS SHALL HAVE APPROVED RADIO COVERAGE FOR EMERGENCY RESPONDERS WITHIN THE BUILDING BASED ON THE EXISTING COVERAGE LEVELS OF THE PUBLIC SAFETY COMMUNICATION SYSTEMS UTILIZED BY THE JURISDICTION, MEASURED AT THE EXTERIOR OF THE BUILDING.
- B. IF THE SIGNAL STRENGTH WITHIN THE BUILDING DOES NOT PASS THE REQUIRED COVERAGE LEVELS, PROVIDE BI-DIRECTIONAL ANTENNA AS DIRECTED BY LOCAL FIRE JURISDICTION.
- C. COMPLY WITH IFC 2018, 907.5.2.1.1 AVERAGE SOUND PRESSURE. AUDIBLE ALARM NOTIFICATION APPLIANCES SHALL PROVIDE A SOUND PRESSURE LEVEL OF 15dBA ABOVE AVERAGE AMBIENT SOUND LEVEL OR 5 dBA ABOVE THE MAXIMUM SOUND LEVEL HAVING A DURATION OF NOT LESS THAN 60-SECONDS, WHICHEVER IS GREATER, IN EVERY OCCUPIABLE SPACE WITHIN THE BUILDING.
- D. COMPLY WITH NFPA 72, 2016 A.13.4.3 AVERAGE AMBIENT SOUND LEVELS BASED ON LOCATION.
- E. FIRE ALARM SYSTEM SHOWN THIS PAGE IS A GENERAL LAYOUT AND IS NOT A FULLY ENGINEERED SYSTEM. FIRE ALARM CONTRACTOR SHALL PROVIDE SHOP DRAWINGS AS A DEFERRED SUBMITTAL TO COMPLY WITH NFPA 72.

KEY NOTES:

- 1. ETR FACP-A SIMPLEX 4005, MAIN FACP IN ADJACENT BUILDING.

MSM ARCHITECTS
DIVISION OF SHIVE-HATTERY
1000 N. CENTRAL AVENUE, SUITE 1000
PHOENIX, AZ 85004
TEL: 602.441.1000
WWW.MSMARCHITECTS.COM



Glass Arts T1 at Santa Rita Springs

Green Valley Recreation
921 W Via Rio Events, Green Valley, AZ 85614

2023/01/24	MESH REVISIONS
KATJAU	S.L.
APPROVED BY	ISSUED FOR
ISSUED DATE	PROJECT NUMBER
21/02/2023	217230103
	FIELD BOOK

7836 N. La Cholla Blvd.
Tucson, Arizona, 85741
Phone (520) 825-2106
Fax (520) 825-2108
www.eda-as.com
Project #: 22078

SYSTEMS PLAN

E3.0

JOB NAME: GVR ART JOB NO: 22078RM ELEC 10S RATED ISC: ETR PANEL NO: ADF
 VOLTAGE: 277/480 PHASE: 3 WIRE: 4 MAIN: BKR TYPE: MOUNTING: SURFACE

REMARKS: EXISTING SIEMENS TYPE S4 PANEL
 (**) DENOTES REPLACE EXISTING BREAKER AS SHOWN

REMARKS:	BKR	CKT	HP	KVA			HP	CKT	BKR	REMARKS:
				A	B	C				
PANEL AZHA	225/3	1						2		NON-BUSSED SPACE
		3						4		
		5						6		
PANEL ATHA	100/3	7		13.9				8	(**)	XFMR
		9		18.9	12.8			10	125/3	PANEL A1LA
		11		19.8				12		
		13				16.7				
		15				18.5				
SPACE		17						14		SPACE
		19						16		
SPACE		21						18		SPACE
		23						20		
								22		
								24		

CONNECTED TOTALS: 32.8 32.5 35.2 -
 LARGEST MOTOR/CONTINUOUS x 1.25: 0.0 0.0 0.0 TOTAL DEMAND (KVA): 100.5
 NON-CONTINUOUS 32.8 32.5 35.2 NON-COINCIDENT (KVA):
 DEMAND: 32.8 32.5 35.2 NET KVA: 101 AMP: 127

JOB NAME: GVR ART JOB NO: 22078RM IT RATED ISC: ETR PANEL NO: CP
 VOLTAGE: 120/208 PHASE: 3 WIRE: 4 MAIN: LUG TYPE: MOUNTING: SURFACE

REMARKS: EXISTING SIEMENS PANEL
 (**) DENOTES REPLACE EXISTING BREAKER AS SHOWN

REMARKS:	BKR	CKT	HP	KVA			HP	CKT	BKR	REMARKS:
				A	B	C				
REC STAIN GL 117	(**)	20/1	1		0.7			2	(**)	OPEN STUDIO 115
	(**)	20/1	3		0.9			4	(**)	
	(**)	20/1	5		0.9			6	(**)	
	(**)	20/1	7		0.7			8	(**)	REC LOUD EQUIP 108
	(**)	20/1	9		1.1			10	(**)	REC COMPUTER
	(**)	20/1	11		0.7			12	(**)	
	(**)	20/1	13		1.1			14	(**)	
REC FRIT 109	(**)	20/1	13		0.9			14	(**)	REFRIG
	(**)	20/1	15		1.5			16	(**)	OPEN STUDIO 115
	(**)	20/1	17		0.5			18	(**)	J-BOX
REC YARD	(**)	20/1	17		1.0			18	(**)	OPEN STUDIO 115
REC COMPUTER	(**)	30/1	19		0.4			20	(**)	
	(**)	30/1	21		1.0			22	(**)	
	(**)	30/1	23		0.4			24	(**)	REC KILN RM 112
	(**)	20/1	25		1.1			26	(**)	
J-BOX YARD	(**)	20/1	25		0.7			26	(**)	REC CLASSRM
K-1 KILN	(**)	30/1	27		2.4			28	(**)	
K-2 KILN	(**)	20/1	29		0.9			30	(**)	
K-3 KILN	(**)	25/1	31		1.7			32	(**)	
AIR COMP 2K	(**)	30/1	33		0.5			34	(**)	60/3 SURGE SUPPRESSOR
VERT BLASE	(**)	20/1	35		1.8			36	(**)	
SPACE	(**)	37			2.9			38	(**)	60/2 K-9 KILN
K-8 KILN	(**)	70/2	39		4.8			40	(**)	
	(**)	41			5.5			42	(**)	SPACE

CONNECTED TOTALS: 15.5 22.5 15.2 -
 LARGEST MOTOR/CONTINUOUS x 1.25: 0.0 0.0 0.0 TOTAL DEMAND (KVA): 43.6
 NON-CONTINUOUS 10.7 17.7 15.2 NON-COINCIDENT (KVA):
 DEMAND: 10.7 17.7 15.2 NET KVA: 44 AMP: 148

JOB NAME: GVR ART JOB NO: 22078RM ELEC 10S RATED ISC: ETR PANEL NO: A1HA
 VOLTAGE: 277/480 PHASE: 3 WIRE: 4 MAIN: LUG TYPE: MOUNTING: SURFACE

REMARKS: EXISTING SIEMENS PANEL
 (**) DENOTES REPLACE BREAKER AS SHOWN
 (##) DENOTES REVISE LOAD AS SHOWN

REMARKS:	BKR	CKT	HP	KVA			HP	CKT	BKR	REMARKS:
				A	B	C				
LTS THIS PROJECT	(##)	20/1	1		2.3			2	20/1	LTS TIMECLOCK
	(##)	20/1	3		2.9			4	20/1	
	(##)	20/1	5		3.6			6	20/1	SPARE
	(##)	20/1	7		4.1			8	20/1	WH-4
WH-2	(##)	20/1	7		4.1			10	20/1	WH-5
WH-3	(##)	20/1	9		4.1			12	20/1	WH-6
REC ROOF	(##)	20/1	11		0.4			14	20/1	WH-6
SPACE	(##)	13			4.1			16	(**)	SPACE
	(##)	15						18	(**)	
	(##)	17			8.0			18	40/1	WH-1

CONNECTED TOTALS: 13.3 11.8 15.8 -
 LARGEST MOTOR/CONTINUOUS x 1.25: 2.8 2.8 4.6 4.2 TOTAL DEMAND (KVA): 43.3
 NON-CONTINUOUS 11.1 8.2 12.5 NON-COINCIDENT (KVA):
 DEMAND: 13.9 12.8 16.7 NET KVA: 43 AMP: 60

JOB NAME: GVR ART JOB NO: 22078RM ELEC 10S RATED ISC: ETR PANEL NO: A1LA
 VOLTAGE: 120/208 PHASE: 3 WIRE: 4 MAIN: BKR TYPE: MOUNTING: SURFACE

REMARKS: EXISTING SIEMENS PANEL (DISCONNECT SHUT-DOWN CONTACTORS/SHUNT TRIP)
 (**) DENOTES REPLACE BREAKER AS SHOWN
 (##) DENOTES REVISE LOAD AS SHOWN

REMARKS:	BKR	CKT	HP	KVA			HP	CKT	BKR	REMARKS:
				A	B	C				
ETR REC	(##)	20/1	1		0.4			2	(##)	ETR DATA SWITCH
ETR REC	(##)	20/1	3		0.7			4	(##)	ETR REC
ETR REC	(##)	20/1	5		0.4			6	(##)	ETR REC
ETR REC	(##)	20/1	7		0.9			8	20/1	F.A. BELL
ETR REC	(##)	20/1	9		0.2			10	20/1	SF-3, SF-4
	(##)	20/1	11		0.5			12	20/1	EF-4, EF-5, EF-6
REC TTB	(##)	20/1	13		0.4			14	20/1	TIMECLOCK
LTS UNDERCABINET	(##)	20/1	15		0.3			16	60/2	(**)
K-4 KILN	(**)	60/2	17		4.6			18	70/2	K-6 KILN
	(**)	19			5.0			20	70/2	K-7 KILN
EF-3	(**)	20/1	21		1.1			22	20/1	
K-5 KILN	(**)	50/2	23		6.0			24	20/1	FILT-1,2,3,4
FACP	(**)	20/1	27		0.5			26	20/1	FILT-5,6,7
SPACE	(**)	20/1	29					28	20/1	
FC-1, FC-2 AC-15	(**)	20/2	31		0.6			32	20/1	SF-1
FC-3, FC-6 FC-7	(**)	20/2	35		1.1			34	20/1	SF-2
	(**)	37			0.2			36	20/1	SPACE
FC-4, FC-5	(**)	20/2	39		1.5			38	100/3	PANEL A2LA
	(**)	41			2.4			40		
	(**)	43			1.6			42		

CONNECTED TOTALS: 18.9 19.7 18.5 -
 LARGEST MOTOR/CONTINUOUS x 1.25: 0.0 0.3 0.0 TOTAL DEMAND (KVA): 57.2
 NON-CONTINUOUS 18.9 19.5 18.5 NON-COINCIDENT (KVA):
 DEMAND: 18.9 19.8 18.5 NET KVA: 57 AMP: 165



MSM ARCHITECTS
 DIVISION OF SHIVE-HATTERY

SEAL
 STATE OF ARIZONA
 REGISTERED PROFESSIONAL ARCHITECT
 No. 10182
 EXPIRES 12/31/2024

Glass Arts Ti at Santa Rita Springs
 Green Valley Recreation
 921 W. Via Rio Fuentis, Green Valley, AZ 85614

2023/01/24 MECH REVISIONS

DRAWN BY	KATAJU
APPROVED BY	S.L.
ISSUED FOR	
ISSUE DATE	12/02/2022
PROJECT NUMBER	217203103
FIELD BOOK	

PANEL SCHEDULES
 E4.0



GREEN VALLEY RECREATION, INC.

REQUEST FOR PROPOSALS

**GVR GLASS ARTISTS TENANT
IMPROVEMENT**

RFP NO: 2023-02-SRS-08

Issued by:

**Green Valley Recreation, Inc.
1070 S Calle De Las Casitas Green
Valley, AZ 85614**

Telephone: 520-625-3440

Issue Date: February 3, 2023

Submittal Due Date: February 22, 2023 at 2:00 p.m.

GREEN VALLEY RECREATION, INC.
Request for Proposals
GVR GLASS ARTISTS TENANT IMPROVEMENT
RFP NO:2023-02-SRS-08

Green Valley Recreation, Inc. (“Organization” aka “GVR”) requests sealed bid proposals from qualified commercial General Contractors to construct a tenant improvement for the GVR Glass Artists Club at the owner’s 921 W. Via Rio Fuerte, Green Valley, AZ, 85614 location.

Copies of the RFP package, including a scope of work, submission requirements and affidavits, may be downloaded from the Organization’s website at www.gvrec.org. From the home page menu on the right side, click on the News and Info tab and then Bids & RFPs. Requests for printed copies should be directed to the Administrative Offices, 1070 S Calle De Las Casitas, Green Valley, AZ 85614, Monday-Friday 10:00 a.m. – 2:00 p.m. (telephone 520-625-3440).

Proposals in response to this RFP must be submitted in hard copy and electronic copy in a sealed envelope, in accordance with the requirements specified in the RFP. Submissions should be marked **GVR GLASS ARTISTS TI RFP NO: 2023-02-SRS-08** and delivered to the **Administration Department, Green Valley Recreation, Inc., 1070 S Calle De Las Casitas, Green Valley, AZ 85614, no later than February 22, 2023 at 4:00 p.m.**

Green Valley Recreation, Inc. is an Equal Opportunity Employer. Employment decisions are made without regard to race, color, religion, national origin, sex, ancestry, marital status, age, sexual orientation, gender identity, disability, or any other legally-protected characteristic.

The Organization reserves the right to reject any and all proposals in the best interest of the Organization.

The contact person for this solicitation is:

David Jund, Facilities Director
Telephone: 520-625-3440
Email: djund@gvrec.org.

GREEN VALLEY RECREATION, INC.
Request for Proposals
GVR GLASS ARTISTS TENANT IMPROVEMENT
RFP NO:2023-02-SRS-08

GENERAL INFORMATION

Green Valley Recreation, Inc. requests proposals from qualified commercial general contractors to execute a Tenant Improvement at GVR's Santa Rita Springs Center. Responses to this request are due by **February 22, 2023 at 4:00 pm**. The Organization anticipates the project commencing as soon as possible. Bidders should submit an anticipated start date and complete schedule.

Green Valley Recreation, Inc. is a non-profit organization serving the leisure and social needs of the adult retirement community of Green Valley, Arizona which is located 25 miles south of Tucson, Arizona on I-19. Green Valley Recreation, Inc. owns and operates one Administrative Offices, Facility Management Building, and fifteen Recreation Centers. Green Valley Recreation, Inc. provides many services and activities to a private membership base of over 13,700 households (an estimated 23,000+ individuals).

PROJECT DESCRIPTION

The Organization is executing a tenant improvement within 4482 SF of the lower level of the Santa Rita Springs Center located at 921 W. Via Rio Fuerte. The project also includes the new build of an attached 375 SF exterior work space with full cover. The project repurposes a former computers space of classrooms, computer lab rooms and storage rooms to a fully dedicated space for the GVR Glass Artists Club.

The work scope will be:

1. Demolition of existing interior walls, flooring and ceiling grid per plans.
2. Construct interior rooms including a 690 SF kiln and holding room.
3. Construct an attached 375 SF exterior work area w/ full roof cover.
4. Existing mechanical units to remain with upgrades to filtration and supply air systems.
5. Installation of required new plumbing and electrical fixtures.
6. New mill work.
7. Enclosure wall, fencing and gates
8. Demo and pour level pad for relocated storage shed.

BIDS WILL BE DUE: February 22, 2023 AT 4:00 p.m.

Sealed bids shall be addressed and submitted to:

GREEN VALLEY RECREATION, INC.
1070 S. Calle de las Casitas
Green Valley, Arizona 85614

- A. Bidder can submit the entire bid package hard copy and electronic copy in a sealed envelope. Bidder must include any and all addenda with the bid package. **Proposals received after the bid date or time may be rejected without consideration. Extensions may be granted by permission of GREEN VALLEY RECREATION, Inc management only.**
- B. The Bidder shall legibly fill out the bid proposal in ink complete with the total and sign the proposal. The Bidder shall submit for consideration the completed AIA Document A101-2017 Standard Form of Agreement Between Owner and Contractor where the basis of payment is a Stipulated Sum. The Additional Terms set forth in the AIA form in Section 8.7 as ‘Other provisions’ shall be the following:

a) Lien. If any notice of lien, stop notice or bonded stop notice is presented to the Owner or recorded, despite payment by the Owner in accordance with the terms of this Agreement, the Owner may withhold from Contractor all sums the Owner considers necessary to protect the Owner from loss or expenses arising from such lien or notice. Provided however, if the Owner becomes aware that any lien, stop notice or bonded stop notice has been presented or recorded, the Owner must notify the Contractor at least ten days in advance before any sums are withheld from Contractor. Further, Contractor will furnish within ten (10) days after demand, at Contractor’s sole cost, all statutory and other bonds necessary to release and discharge the Project or any of the Owner’s property from liens and to result in the release of funds held in response to any notice or bonded stop notice despite payment by Owner in accordance with the terms of this Agreement.

b) Time. If during the performance of Work the delivery of materials, equipment or products are delayed through no fault of Contractor due to factors including supply chain shortages, unavailability of transportation, labor shortages or other similar factors, the Project Schedule shall be adjusted for such delays and Contractor shall not be liable for such delays.

c). Attorney Fees In the event any claim resulted in arbitration, the arbitrator shall award the prevailing party its attorney fees and costs.

If the bid is accepted, the AIA Document A101-2017 will form the final and complete contract between the parties.

- C. The Bidder shall complete the list of subcontractors and suppliers and submit with their bid packages.
- D. The Tenant Improvement of GVR Glass Artists shall be bid **Lump Sum**. It is the contractor’s

responsibility to determine all quantities for the items shown on the bid proposal. Contractors shall bid all items listed on the bid proposal. All Contractors shall be required to insert their quantities and unit prices in the spaces provided in the bid proposal. The items shown on the bid proposal shall not be considered inclusive of all work to be performed. Additional lines are available for Contractors to insert additional items as needed. The bid price shall be a **Lump Sum** price unless there is a change in the plans after the bid date. The Bidder agrees that the unit prices for the items shown on the bid proposal will be used only to establish the value of changes in the scope of work if plan revisions are necessary.

The Bidder agrees to guarantee their bid for one hundred twenty (120) days from the project start date of each work description as outlined in “**Contract Time & Extension.**” A pre-award conference may be held with the apparent successful Bidder to review plans, specifications, contracts and the construction schedule.

Upon the request of GREEN VALLEY RECREATION, INC., the apparent successful Bidder shall submit a list of equipment with rental rates for possible time and materials work.

The bid opening will be private. The Owner or Organization reserves the right to reject any or all bids, with or without cause, and to waive technical errors and formalities. The lowest bid may not necessarily be accepted. The Owner or Organization intends to accept the proposal that in their sole judgment best serves their interests.

SUBMISSION REQUIREMENTS

Documents to be submitted with Proposal include an original, two copies, and one electronic copy of each of the following:

- Bid Proposal Form - An authorized representative who can make a binding commitment for the firm must sign the Bid Proposal Form.
- Information Regarding the Bidder Form, including three references with complete contact information for three different construction projects completed within the past five years.
- A written proposal outlining the recommended process and schedule for completing the above tasks.
- A budget for the project based on the tasks listed or proposed. The budget should clearly indicate the cost for distinct parts of the project.

Green Valley Recreation, Inc. is an Equal Opportunity Employer. Discrimination based on age, race, color, creed, religion, national origin, ancestry, disability, marital status, sex, sexual orientation, gender identity, or physical characteristic is expressly prohibited.

All materials submitted in response to this Request for Proposals will become the property of Green Valley Recreation, Inc. The Organization agrees, to the extent permitted by law, to hold in strictest confidence all material and information belonging to the bidder which it deems to contain confidential business or financial information.

Proposals in response to this RFP must be submitted in a sealed envelope containing the name and

address of the Bidder, in accordance with the requirements specified in the RFP. Submissions should be marked **GVR GLASS ARTISTS TI RFP NO: 2023-02-SRS-08** and delivered to the **Facilities Department, Green Valley Recreation, Inc., 1070 S Calle De Las Casitas, Green Valley, AZ 85614, no later than February 22, 2023 at 4:00 p.m.**

REVIEW OF QUALIFICATIONS

The Organization will review all submissions for responsiveness to this RFP. The review will consider the experience of the contractor, recent work on similar projects, anticipated timeline, and project references. The Organization may request additional information and reserves the right to reject any or all proposals as is in its best interest.

AWARD OF CONTRACT

Bidders may bid only on the entire Project. The Board of Directors of Green Valley Recreation, Inc. will select the successful Bidder. In determining which proposal is best, the Organization will take into consideration the bid price and the experience, qualifications, references, responsibility, and current availability of the bidder to perform the work. The Organization reserves the right to exercise its sole discretion to best serve the interests of the Organization. Except where the Organization exercised the right reserved herein to reject any or all proposals, each Agreement will be awarded on a lump sum basis, as is in the best interest of Green Valley Recreation, Inc.

The successful Bidder shall be required to execute an AIA Document A101-2017 Standard Form of Agreement Between Owner and Contractor where the basis of payment is a Stipulated Sum. Green Valley Recreation, Inc. reserves the right to cancel the Award of the Agreement at any time prior to execution of the Agreement without liability on the part of the Organization.

EXECUTION OF THE AGREEMENT

The successful Bidder must execute the Agreement within 10 business days after the award and submit such other Documents and insurance certificates as required by the Contract Documents. Failure by the Contractor to execute the Agreement and submit such other documents as required by the Contract Documents shall be just cause for annulment of the Award.

A Bidder may submit only one proposal for the Agreement. More than one proposal from an individual, firm or partnership, corporation or association under the same or different names will not be considered on any given Agreement and will be considered grounds for disqualification and/or rejection of the proposals involved, unless prior approval has been given by the Organization.

INVITATIONS TO SUBMIT PROPOSALS A COURTESY

This invitation to bid may be sent as a courtesy to known interested parties. The receipt of this request for proposals from Green Valley Recreation, Inc. in no way implies that the recipient is a qualified Bidder.

INTERPRETATIONS

All questions about the meanings or intent, discrepancies or omissions of the Contract Documents shall be submitted via email to David Jund, Facilities Director, e-mail: djund@gvrec.org by Thursday

February 15, 2023 at 2:00 p.m. The written responses, including any changes to the RFP, become part of the Contract Documents and will be posted on the Organization website as an addendum by 4:00 p.m. February 17, 2023. It is the responsibility of each Bidder to visit the Organization's website at www.gvrec.org from the home page on the right side under the News and Info tab and then Bids & RFPs to obtain any addenda or other information regarding the RFP.

SPECIAL CONDITIONS

Definitions:

The following definitions shall apply to specifications, contracts, bonds and insurance:

Owner: GREEN VALLEY RECREATION, INC.
1070 S. Calle de las Casitas, Green Valley, Arizona 85614
(520) 625-3440

Architect: WSM, A DIVISION OF SHIVE-HATTERY
4330 N CAMPBELL AVE #268
TUCSON, AZ 85718
520.408.1004

Structural Engineer: SCHNEIDER AND ASSOCIATES
435 E 9TH ST
TUCSON, AZ 85705
520.512.8183

Mechanical Engineer: PH MECHANICAL
333 N WILMONT RD #201
TUCSON, AZ 85711
520.731.2060

Electrical Engineer: ELECTRICAL DESIGN ASSOCIATES (EDA)
7536 N LA CHOLLA BLVD
TUCSON, AZ 85741
520.622.2196

PLANS AND SPECIFICATIONS

These plans accompany and are made part of the Project Specifications and Contract Documents.

PROJECT: **GVR GLASS ARTISTS TI RFP NO: 2023-02-SRS-08**

Link to Approved Plans:

<https://www.gvrec.org/up/news-info/misc/2023/GVR%20Glass%20Arts%202023-02-06%20for%20bid.pdf>

CONTRACT TIME & EXTENSION

The Contractor shall notify the Owner or Organization in writing within 72 hours of any circumstances or events that the Contractor believes may justify an extension of time. Failure to do so may result in rejection of the request.

BID GUIDELINES

All bids must include a schedule with an estimated time to completion. *This will be a determining factor when bids are awarded. Certain jobs may have time restrictions disclosed in the “Scope of Work” section of this bid letter. Note these limits and bid accordingly.*

Site must be returned to original condition prior to issuance of final payment, less retention. Contractor must schedule a walk through with a Green Valley Recreation Representative prior to start & immediately following completion. A written record of the walk through will be provided by Green Valley Recreation.

Presentation of a bid will confirm that Contractor has visited the site and is satisfied as to the condition of the site.

Contractor agrees to employ only persons possessing the experience and training needed for the completion of said work as outlined in the “Scope of Work” and further insures that a “competent party”, must also be able to communicate with the Green Valley Recreation Representative, will be in control of the site and work at all times while work is in progress. **An emergency contact name and number must be provided on 24 hour/7 days a week.**

Contractor will strictly adhere to all labor and safety laws and regulations while work is in progress, for all governing authorities.

Coordination of municipal and private inspections shall be contractor’s responsibility. All work shall be completed in strict conformance with the requirements of all municipal and regulatory agencies. All work shall be completed in strict accordance with the plans and specifications or as shown in the “Plan Notes” below, or as required by governing municipality whichever is most restrictive.

Contractor will conduct operations in such a manner as to cause no undo hazard to exist.

Contractor shall ensure that the general public and all persons affected by the “Scope of Work” are dealt with in a courteous manner.

Permits will be obtained by the Contractor.

Organization has the right to award all or part of the improvements.

Contractors will be responsible to verify that all supervisor personnel have the most recent set of plans pertaining to the work being performed. Any costs for incorrect work performed because the contractor's field personnel had the incorrect plans will be the Contractor's responsibility.

All work will be performed in strict accordance with the project Contract Documents.

GENERAL INFORMATION

The Contractor shall keep his work area clean at all times. All waste generated by the Contractor will be disposed of away from the site. The cost of this work shall be included in the Contractors bid.

Work areas not kept clean shall be cleaned by the Organization. The cost to do this will be deducted from the Contractor's payment.

The Contractor will themselves assess the site and all existing conditions and shall bear the cost of repair of any damage to these existing facilities caused by the Contractor. The Contractor must notify the Organization immediately of any damage.

The Contractor is responsible to notify Blue Stake, the town, the city, and / or Pima County before beginning work. The Contractor shall request Blue Stake updates as necessary to keep markings current.

Contractor shall also have all punch list items completed within 10 working days of receipt of punch list and notification.

WATER SOURCE

The Organization shall supply, at their expense, construction water, to be used for dust control, excavation and backfill operations, deliveries, general traffic and incidentals during construction phase.

WORK SCOPE

The work to be performed under this contract will include the approximately 4482 SF of interior space with partition walls. Suspended ceilings in some rooms. Also, included is a fully covered 375 SF exterior work area enclosure as shown on the Plans.

INFORMATION REGARDING THE BIDDER

1. Name of Bidder:

(Individual/Firm/Corporation)

Address: _____

Telephone: _____ FAX: _____

E-mail Address: _____

2. Please provide the following information concerning work that you have done within the last five (5) years which is similar to the Bid work.

FOR WHOM PERFORMED	CONTRACT AMOUNT	DATE COMPLETED	CONTACT'S NAME/ TELEPHONE NUMBER
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3. Please provide at least three references, including any Arizona non-profit or governmental units or agencies for whom you have worked on a similar project. Include the name and telephone number of your contact with each reference.

4. Identify all subcontractors that you intend to use in performing the work under the Contract and specify the work each is expected to perform.

Dated this _____ day of _____, 2023.

Name of Bidder: _____ By: _____

Printed Name: _____ Title: _____



GREEN VALLEY RECREATION, INC.
NOTICE OF INVOICE
REVISION

Co: _____

Fax No: _____

Attn: _____

Date Faxed: _____

No of Pages: _____

Project: _____

Billing Period: _____

Please be advised that your invoice for the above referenced project and period has been revised for the following reason (s): **PLEASE REVISE ALL RECORDS TO REFLECT THESE CHANGES, FUTURE INVOICES NOT ADJUSTED WILL BE REJECTED.**

- PERCENT COMPLETE ON THE ATTACHED INVOICE # _____ HAS BEEN REVISED TO _____%, DUE TO _____
- REVISED DUE TO INCORRECT CALCULATIONS, I.E. INCORRECT TAX RATE, WRONG ADDITION, ETC.
- RETENTION _____% or \$ _____ WILL BE SUBMITTED FOR PAYMENT. PLEASE SUBMIT INVOICE FOR BALANCE ON OR BEFORE THE NEXT BILLING PERIOD. _____

- INVOICE # _____ ADJUSTED TO REFLECT 10% RETENTION HELD.
- OTHER: _____

ABOVE ITEM(S) MUST BE SUBMITTED IN ORIGINAL FORM BY:

IF YOU HAVE ANY QUESTIONS, PLEASE CONTACT: _____



GREEN VALLEY RECREATION, INC.
NOTICE OF INVOICE
REJECTION

Co: _____

Project: _____

Attn: _____

Billing Period: _____

Please be advised that your invoice for the above referenced project and period has been rejected for the following reason (s):

- INVOICE # _____ RECEIVED AFTER CUT OFF DATE OF: _____.
- CHANGE ORDER IS NOT EXECUTED FOR INVOICE # _____.
- CONTRACT IS NOT FULLY EXECUTED.
- INVOICE # _____ NOT SUBMITTED ON ORGANIZATION'S INVOICE FORM INCLUDED IN YOUR CONTRACT.
- CONDITIONAL RELEASE FOR INVOICE # _____ NOT ATTACHED TO OWNER'S INVOICE FORM.
- RECEIVED FAXED COPY OF INVOICE # _____. **ONLY ORIGINALS ACCEPTED!**
- RETENTION CANNOT BE SUBMITTED FOR PAYMENT DUE TO:
 - FINAL ACCEPTANCE NOT COMPLETE
 - OUTSTANDING BACKCHARGES
- MUST ATTACH CONDITIONAL LIEN RELEASE INCLUDED WITH YOUR CONTRACT.
- PREVIOUS INVOICE ADJUSTMENTS NOT REFLECTED ON CURRENT INVOICE # _____.
- OTHER: _____

ABOVE ITEM (S) MUST BE SUBMITTED IN ORIGINAL FORM BY:

IF YOU HAVE ANY QUESTIONS, PLEASE CONTACT: _____



GREEN VALLEY RECREATION, INC

LIST OF SUPPLIERS AND SUBCONTRACTORS FOR PROJECT

Supplier or Subcontractor:	Est. Value:
Type of Trade or Supplies provided to Project:	
Company	
Contact:	
Address, City, State & Zip:	
Phone:	
Supplier or Subcontractor:	Est. Value:
Type of Trade or Supplies provided to Project:	
Company	
Contact:	
Address, City, State & Zip:	
Phone:	Fax:
Supplier or Subcontractor:	Est. Value:
Type of Trade or Supplies provided to Project:	
Company	
Contact:	
Address, City, State & Zip:	
Phone:	Fax:



GREEN VALLEY RECREATION, INC.
REPORT OF FIELD CHANGE

PROJECT: _____ **RFC#** _____

TO: _____ **DATE:** _____
(Contractor)

ORGANIZATION APPROVAL RECEIVED: Y N **TIME:** _____ **DATE:** _____

ORGANIZATION CONTACT: _____

CONTRACTOR: You are authorized to perform the work described in this Report of Field Change. This form must accompany any invoice or proposal for work outlined herein and must be returned to Owner's office within 72 hours of completion of work. Failure to turn in proper documentation may result in delay of payment for such.

Detailed Identification of Problem: _____

Detailed Solution Proposed or Accomplished: _____

Comments: _____

Contract Impact: ADD: Y N DEDUCT: Y N CONTRACT EXTENSION: Y N

Estimated Cost: \$ _____

Back Charge: Y N _____ Contractor _____ Date Notified _____

Prepared By: _____ **Received By:** _____
GREEN VALLEY RECREATION, INC CONTRACTOR



NOTIFICATION OF BACK CHARGE No. _____

Date: October 1, 200X
Project: project name
Organization: GREEN VALLEY RECREATION, INC.
Issued By: _____
Contractor(s) to be Back charged: ABC Company
Date Work Performed: _____
Reason for Back charge: Re-stake returns that were previously staked.
Contractor Performing Work: AAA Construction
Back charge Amount: \$765.00

The actual back charge amount will be deducted from Contractor's total contract sum. This back charge covers a period through _____, for the purpose noted above and does not cover any retention, pending modifications and changes, or items furnished after that date.

IF THE CONTRACTOR DISPUTES THE BACKCHARGE, THEY MUST VERBALLY NOTIFY ORGANIZATION IMMEDIATELY UPON RECEIPT OF THIS NOTIFICATION, AND FOLLOW UP WITH WRITTEN NOTIFICATION WITHIN FORTY-EIGHT (48) HOURS OF RECEIVING THIS NOTIFICATION. TIME IS OF THE ESSENCE. FAILURE TO DISPUTE THIS BACKCHARGE IN WRITING WITHIN THE 48 HOURS SHALL AUTOMATICALLY CONSTITUTE CONTRACTOR ACCEPTANCE. This will enable both parties to have the opportunity to resolve the dispute in a timely manner, to prevent project delays. Organization will not withhold any pay application due to an unresolved back charge, provided Organization has been properly notified. NOTE: EMERGENCY ITEMS REQUIRING IMMEDIATE REPAIR OR MODIFICATION MAY NOT ALLOW FOR A 48-HOUR NOTIFICATION. THIS WILL NOT RELIEVE THE RESPONSIBLE CONTRACTOR OF FINANCIAL RESPONSIBILITY FOR REPAIRS.

RECEIVED BY: _____
Name Contractor Date

VERBALLY NOTIFIED: _____
Name Contractor Date



CONDITIONAL WAIVER AND RELEASE ON PROGRESS PAYMENT

(Pursuant to A.R.S. §33-1008)

Project: GVR GLASS ARTISTS TENANT IMPROVEMENT

Organization: Green Valley Recreation, Inc.

On receipt by the undersigned of a check from Green Valley Recreation, in the sum of \$_____ payable to *Contractor Name*, and when the check has been properly endorsed and has been paid by the bank on which it is drawn, this document becomes effective to release any mechanic's lien, any state or federal statutory bond right, any private bond right, any claim for payment and any rights under any similar ordinance, rule or statute related to claim or payment rights for persons in the undersigned's position that the undersigned has on the job of Green Valley Recreation, Inc., located at Desert Hills Center, 2980 S. Camino Del Sol, Green Valley, Arizona 85614. to the following extent.

This release covers a progress payment for all labor, services, equipment or materials furnished to the jobsite or to Green Valley Recreation, Inc., through _____ only and does not cover any retention, pending modifications and changes or items furnished after that date. Before any recipient of this document relies on it, that person should verify evidence of payment to the undersigned.

The undersigned warrants that they either have already paid or will use the monies they receive from this progress payment to promptly pay in full all of their laborers, subcontractors, materialmen and suppliers for all work, materials, equipment or services provided for or to the above referenced project up to the date of this waiver.

DATE: _____

(Contractor)

By: _____

(Signature)

(Print Name)

(Title)



CONDITIONAL WAIVER AND RELEASE ON FINAL PAYMENT
(Pursuant to A.R.S. §33-1008)

Project: GVR GLASS ARTISTS TENANT IMPROVEMENT
Organization: Green Valley Recreation, Inc.

On receipt by the undersigned of a check from Green Valley Recreation, in the sum of \$_____ payable to *Contractor Name*, and when the check has been properly endorsed and has been paid by the bank on which it is drawn, this document becomes effective to release any mechanic's lien, any state or federal statutory bond right, any private bond right, any claim for payment and any rights under any similar ordinance, rule or statute related to claim or payment rights for persons in the undersigned's position, the undersigned has on the job of Green Valley Recreation, Inc., located at Desert Hills Center, 2980 S. Camino Del Sol, Green Valley, Arizona 85614.

This release covers the final payment to the undersigned for all labor, services, equipment or materials furnished to the jobsite or to Green Valley Recreation, Inc., except for disputed claims in the amount of \$_____. Before any recipient of this document relies on it, the person should verify evidence of payment to the undersigned.

The undersigned warrants that they either have already paid or will use the monies they receive from this final payment to promptly pay in full all of his laborers, subcontractors, materialmen and suppliers for all work, materials, equipment or services provided for or to the above referenced project up to the date of this waiver.

DATE: _____

(Contractor)

By: _____

(Signature)

(Print Name)

(Title)



UNCONDITIONAL WAIVER AND RELEASE ON PROGRESS PAYMENT

(Pursuant to A.R.S. §33-1008)

Project: GVR GLASS ARTISTS TENANT IMPROVEMENT

Organization: Green Valley Recreation, Inc.

The undersigned has been paid and has received a progress payment in the sum of \$_____ for all labor, services, equipment or material furnished to the jobsite, located at Desert Hills Center, 2980 S. Camino Del Sol, Green Valley, Arizona 85614 and does hereby release any mechanic's lien, any state or federal statutory bond right, any private bond right, any claim for payment and any rights under any similar ordinance, rule or statute related to claim or payment rights for persons in the undersigned's position that the undersigned has on the above referenced project to the following extent.

This release covers a progress payment for all labor, services, equipment or materials furnished to the jobsite or to Green Valley Recreation, Inc., through _____ only and does not cover any retention, pending modifications and changes or items furnished after that date.

The undersigned warrants that they either have already paid or will use the monies they receive from this progress payment to promptly pay in full all of their laborers, subcontractors, materialmen and suppliers for all work, materials, equipment or services provided for or to the above referenced project up to the date of this waiver.

DATE: _____

(Contractor)

By: _____
(Signature)

(Print Name)

(Title)

NOTICE: THIS DOCUMENT WAIVES RIGHTS UNCONDITIONALLY AND STATES THAT YOU HAVE BEEN PAID FOR GIVING UP THOSE RIGHTS. THIS DOCUMENT IS ENFORCEABLE AGAINST YOU IF YOU SIGN IT, EVEN IF YOU HAVE NOT BEEN PAID. IF YOU HAVE NOT BEEN PAID, USE A CONDITIONAL RELEASE FORM.



UNCONDITIONAL WAIVER AND RELEASE ON FINAL PAYMENT
(Pursuant to A.R.S. § 33-1008)

Project: GVR GLASS ARTISTS TENANT IMPROVEMENT
Organization: Green Valley Recreation, Inc.

The undersigned has been paid in full for all labor, services, equipment or material furnished to the jobsite or to Green Valley Recreation, Inc., located at Desert Hills Center, 2980 S. Camino Del Sol, Green Valley, Arizona 85614 and does hereby waive and release any right to mechanic's lien, any state or federal statutory bond right, any private bond right, any claim for payment and any rights under any similar ordinance, rule or statute related to claim or payment rights for persons in the undersigned's position, except for disputed claims for extra work in the amount of \$0.00.

The undersigned warrants that they either have already paid or will use the monies they receive from this final payment to promptly pay in full all of their laborers, subcontractors, materialmen and suppliers for all work, materials, equipment or services provided for or to the above referenced project.

DATE: _____

(Contractor)

By: _____

(Signature)

(Print Name)

(Title)

NOTICE: THIS DOCUMENT WAIVES RIGHTS UNCONDITIONALLY AND STATES THAT YOU HAVE BEEN PAID FOR GIVING UP THOSE RIGHTS. THIS DOCUMENT IS ENFORCEABLE AGAINST YOU IF YOU SIGN IT, EVEN IF YOU HAVE NOT BEEN PAID. IF YOU HAVE NOT BEEN PAID, USE A CONDITIONAL RELEASE FORM.